

Report to Planning Committee

15th February 2022

Application Reference	DC/21/66305
Application Received	5 th November 2022
Application Description	Proposed development of 7 No. houses, 2 No. bungalows and 2 No. two storey apartment blocks comprising of 6 No. self-contained flats with associated parking and landscaping.
Application Address	Land At Hawes Lane/Stanford Drive Rowley Regis
Applicant	Mr Alan Martin Sandwell Metropolitan Borough Council
Ward	Rowley
Contact Officer	Mr Andrew Dean andrew_dean@sandwell.gov.uk

1 Recommendations

- 1.1 That planning permission is granted subject to conditions relating to:
 - (i) External materials;
 - (ii) Parking to be implemented and retained;
 - (iii) Contaminated land;
 - (iv) Finished floor levels;
 - (v) Boundary treatments;
 - (vi) Noise assessment and mitigation measures;



- (vii) Electric vehicle charging points;
- (viii) Renewable energy;
- (ix) Hard and soft landscaping scheme to be implemented;
- Surface water drainage scheme to be implemented, retained and maintained;
- (xi) Foul sewage drainage scheme;
- (xii) External lighting scheme;
- (xiii) Method of working statement;
- (xiv) Removal of permitted development rights for enlargements;
- (xv) Employment and skills plan;
- (xvi) Refuse and cycle storage to be implemented and retained'
- (xvii) Low NOx boilers; and
- (xviii) Garages to be retained for parking.

2 Reasons for Recommendations

2.1 The development would provide much needed affordable housing of good design quality, compliant with national and local planning policy, with no undue harm to the amenities of the surrounding area or to the safety and convenience of users of the highway.

3 How does this deliver objectives of the Corporate Plan?

	Quality homes in thriving neighbourhoods – The design of the proposal is acceptable in respect of national and local planning policy.
23	A strong and inclusive economy

4 Context

4.1 This application is being reported to your Planning Committee because 13 objections against the proposal have been received. Furthermore, Sandwell Metropolitan Borough Council is applicant and the application is major in nature.



4.2 To assist members with site context, a link to Google Maps is provided below:

Land at Hawes Lane and Stanford Drive, Rowley Regis

5 Key Considerations

- 5.1 The site is allocated for housing in the Development Plan.
- 5.2 The material planning considerations which are relevant to this application are:-

Government policy (NPPF) Proposals in the Development Plan Planning history (including appeal decisions) Overlooking/loss of privacy Loss of light and/or outlook Overshadowing Public visual amenity Layout and density of building Design, appearance and materials Access, highway safety, parking and servicing Traffic generation


6. The Application Site

- 6.1 The application site is split between two parcels of land located on the northern side of Hawes Lane, Rowley Regis. The site is bisected by Stanford Drive which serves 14 residential dwellings. The character of the surrounding area is predominantly residential in nature, with a section of the larger site to the north bound by a churchyard.
- 6.2 Both parcels of the application site consist of a north to south sloping area of grassland and contain a number of mature trees in various locations.



7. Planning History

- 7.1 An application for a residential development consisting of the erection of 15 flats, 3 houses and community facilities was refused planning permission by the Planning Committee under application reference DC/99/35926. This decision was contrary to officer recommendation. The reasons for refusal were as follows:
 - i) The proposed development would be situated close to the junction of Stanford Drive and Hawes Lane (B4174) and it is considered that, because of the proximity of these roads to the application site and the proposed occupants of the building, there would be detriment to the safety and convenience of users of the highway
 - ii) The proposed development would detract from the residential amenity of the area.
- 7.2 The below image shows the proposed site layout of the refused 1999 application.

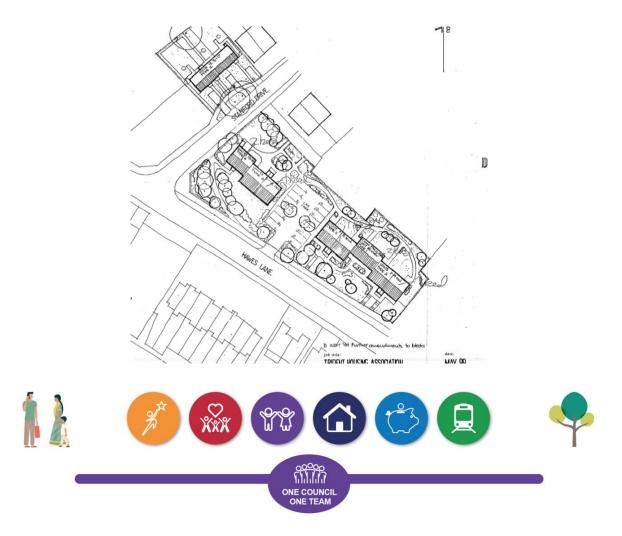

7.3 Relevant planning applications are as follows:

DC/99/35926	Erection of 15 flats, 3	Refusal.
	houses and community	30.12.1999.
	facilities inc. parking and	
	site works.	

8. Application Details

- 8.1 The applicant is proposing to erect 7 No. houses, 2 No. bungalows and 2 No. two storey apartment blocks comprising of 6 No. self-contained flats with associated parking and landscaping.
- 8.2 The development would consist of the following properties:
 - 1 No. 2 bed dwelling with an internal floor area of 72.8m2.
 - 2 No. 3 bed dwellings with an internal floor area of 85.8m2.
 - 1 No. 4 bed dwellings with an internal floor area of 115.3m2.
 - 2 No. 2 bed dwellings with an internal floor area of 72.8m2.
 - 2 No. bungalows with an internal floor area of 72.8m2.
 - 1 No. 3 bed dwelling with an internal floor area of 105.8m2.
 - 6 No. 1 bed flats with four units having an internal floor area of 51.2m2 and 2 units having an internal floor area of 52.6m2.
- 8.3 Each dwelling would have private amenity space in the form of rear garden areas with the proposed flats having a communal drying area and courtyard garden.

9. Publicity

9.1 The application has been publicised by neighbour notification letter and press notice with 14 objections to the application being received.



9.2 **Objections**

Objections have been received on the following grounds:

- Highway safety grounds including issues regarding vehicle parking;
- ii) Loss of wildlife and the grassed area is used by residents for dog walking and as a children's play area;
- iii) The submitted Design and Access Statement contains errors including the incorrect site address;
- iv) Drainage concerns;
- v) The property at the rear of 40 Hawes Lane is on a higher level and would result in a loss of privacy;
- vi) The proposal would result in a loss of light and overshadowing caused by the proposal; and
- vii) The use of the properties for social housing has the potential to increase anti-social behaviour in the area.

Immaterial objections have been raised regarding loss of property value, loss of view, loss of area appeal and water pressure issues.

9.3 Responses to objections

I respond to the objector's comments in turn:

- (i) See material considerations section 13.4.
- (ii) The site in question is not allocated as public open space or a wildlife corridor. The site is allocated for residential development in the Development Plan. A number of mature trees on the site would remain with additional tree planting proposed to replace those which would be lost.
- (iii) This was an error and has been corrected.
- (iv) The submitted surface water drainage scheme has been assessed by the Lead Local Flood Authority who have no objections to the drainage scheme. A condition for foul drainage to be provided



before commencement on site has been included within the recommendation.

- (v) It is noted that the dwellings to the rear of No. 38 and 40 Hawes Lane would be located on a higher ground level due to the levels change of Stanford Drive. However, these properties have been designed to be bungalows which step up the street. These properties would not face directly onto the properties on Hawes Lane. Rear amenity space of the bungalows would contain a 1.8m close boarded fences to the garden area. Furthermore, the dwellings achieve the required 14 metre separation distance required between a windowed rear elevation and a gable side wall. The only window in this elevation would be a shower room window. On this basis, I do not consider a significant loss of privacy would occur.
- (vi) See material considerations section 13.6.
- (vii) Anti-social behaviour by potential residents is a matter for the police and landlord.

10. Consultee responses

- 10.1 Planning Policy No objection. The application is on land that is allocated for residential development in the Development Plan, and previous development plans (SAD H1 Housing Allocations). The proposal meets the requirements of HOU2 Housing Density type and Accessibility for a range of types of dwellings. SAD H3 Affordable Housing also applies, and its requirements are met by the proposal.
- 10.2 **Highways –** No objections. Further comments from Highways in response to the objectors' comments are as follows. The trip rates associated to a small residential development such as this would not generate significant levels of traffic for Highways to consider that the impact on the highway network would be classed as severe. Stanford Drive benefits from a grit bin to assist residents during periods of inclement weather such as ice and snow. Existing properties 38/40 Hawes Lane have vehicular access from Hawes Lane, as do residential dwellings on the opposite side of Hawes Lane. The parking courts



proposed for this development have been designed to allow for vehicles to enter, turn and leave in a forward gear so that driver visibility is improved (no reversing onto the Hawes Lane). The numbers and sizes of off-street parking spaces meet with the standards detailed in the residential developers' guide. Highways have requested an alternative boundary treatment at the junction of Hawes Lane and Stanford Drive (plots 3 and 4) due to concerns the 1 metre high railings proposed could create a solid visual barrier, which in turn would reduce visibility. A condition for boundary details has been included within the recommendation.

- 10.3 **Public Health (Air Quality)** No objections subject to conditions for electric vehicle charging points and low NOx boilers being used.
- 10.4 **Public Health (Contaminated Land)** No objections subject to a contaminated land condition.
- 10.5 **Public Heath (Air Pollution and Noise)** No objection subject to a condition for a noise assessment being undertaken and mitigation measures being submitted and approved. A further condition for the submission of a working on site method statement to include the hours of working to be 08.00 to 17.30 Monday to Friday, 09.00 to 13.00 Saturdays with no working on Sundays or Bank Holidays has been included within the recommendation.
- 10.6 West Midlands Police No objection.
- 10.7 **Lead Local Flood Authority –** No objection to the submitted surface water drainage scheme.
- 10.8 **Severn Trent** No objection subject to conditions for foul and surface water drainage.
- 10.9 **Urban Design Officer** No objection to the proposed site layout, scale and boundary/landscape details. An amended plan has been received to include hit/miss string detailing for the bungalows alongside the front



door. Clarification on bin storage for the apartments was also sought confirming one bin store would contain euro bins and one wheelie bins.

11. National Planning Policy

- 11.1 National Planning Policy Framework promotes sustainable development but states that local circumstances should be taken into account to reflect the character, needs and opportunities for each area.
- 11.2 Taking into account the views of the Council's Urban Design officer, I am of the opinion that the scheme is of a good design, in accordance with paragraph 124 of the NPPF.
- 11.3 In respect of paragraphs 128-130 of the NPPF, the Urban Design officer raises no objections to the scheme. The development would assimilate with the overall form and layout of the site's surroundings.

12. Local Planning Policy

12.1 The following polices of the council's Development Plan are relevant:

HOU2: Housing Density type and Accessibility ENV3: Design Quality ENV5: Flood Risk, Sustainable Drainage System and Urban Heat Island Effect ENV7: Renewable Energy ENV8: Air Quality TRAN4: Creating Coherant Networks for Cycling and Walking. SAD H1: Housing Allocations. SAD H3: Affordable Housing SAD EOS9: Urban Design Principles SAD HE5: Archaeology & Development Proposals. SAD EMP2: Training and Recruitment.



- 12.2 The site is allocated for residential development in the Development Plan. The proposal therefore complies with SAD H1: Housing Allocations.
- 12.3 HOU2 identifies the need for a range of types and sizes of accommodation within the borough and accessibility in terms of sustainable transport to residential services. The proposed site layout confirms the development would contain a mixture of dwelling sizes and types. The proposal is also within proximity to two bus stops on Hawes Lane providing sustainable transport links.
- 12.4 ENV3 and SAD EOS9 refers to well designed schemes that provide quality living environments. The proposed layout and design are considered to be acceptable with no concerns being raised from Urban Design.
- 12.5 ENV5 seeks the incorporation of sustainable drainage systems to assist with reducing the impact of flooding and surface run-off. The Lead Local Flood Authority has raised no objections to the application.
- 12.6 A condition to ensure that at least 10% of the estimated residual energy demand of the development is generated by energy from renewable sources has been included within the recommendation and therefore accords with Policy ENV7.
- 12.7 ENV8 refers to mitigation measures to offset air quality issues. In this instance, conditions for electric vehicle charging points and low NOx boilers to be provided have been recommended.
- 12.8 TRAN4 requires scheme to be well connected to aid cycling and walking. The proposal includes cycle storage for the two apartment buildings.
- 12.9 SAD H3 sets out the requirement of 25% affordable housing. As the applicant is the local authority and the proposal is to provide social housing. The requirement of this policy has been achieved.



- 12.10 The submitted archaeological desk-based assessment meets the requirements of SAD Policy HE5 Archaeology & Development Proposals.
- 12.11 SAD EMP2 requires large employment generating schemes to provide opportunities for training and recruitment. This has been conditioned to secure these opportunities.

13. Material Considerations

13.1 National and local planning policy considerations have been referred to above in Sections 11 and 12. With regards to the other material considerations, these are highlighted below:

13.2 Proposals in the Development Plan

The site is allocated for housing. The proposal therefore accords with the site allocation.

13.3 Planning history (including appeal decisions)

It is noted that a previous application for a residential development of 15 flats, 3 houses and community facilities including parking and site works was refused planning permission under application reference DC/99/35926. The planning committee at the time felt this proposal would impact on highway safety and the development would harm public visual amenity. The planning officer had recommended the application for approval subject to conditions. The design and layout of the current application is materially different to the refused application.

13.4 Access, highway safety, parking, servicing and Traffic generation

The Head of Highways has reviewed the proposal and raised no objections to the application. The current application differs from the previously refused application in that 14 apartments were proposed to be accessed from Hawes Lane and 3 houses from Stanford Drive. The



current application is proposing three smaller accesses from Hawes Lane with one serving two dwellings and two serving three apartments each. Vehicles using these parking areas would be able to enter and leave in forward gear. The remainder of the properties would be accessed from Stanford Drive and would therefore use the existing junction. It should also be noted that paragraph 111 of the National Planning Policy Framework states "Development should only be prevented or refused on highways grounds if there would be an unacceptable impact on highway safety, or the residual cumulative impacts on the road network would be severe". Taking into consideration the Head of Highways has raised no objections to this application, I do not consider the proposed impact of the development on highway safety to be severe. In terms of parking space allocation, the development has been designed to accord with the council's adopted off street car parking requirements of Appendix 3 of the Revised Residential Design Guide SPD. This requirement is as follows:

1 to 2 bed dwellings – 1 dedicated off street parking space.
3 to 4 bed dwellings – 2 dedicated off street parking spaces.

13.5 Loss of light and/or outlook, Overshadowing and loss of privacy.

In terms of properties located on Stanford Drive, the proposed development is located on a lower ground level than these dwellings and no breach of the 45-degree code line would take place from habitable rooms of these properties. I am therefore satisfied no significant loss of light, outlook, overshadowing or privacy would occur. In terms of No. 38 and 40 Hawes Lane, the proposed site layout includes two dwellings to the rear of these properties which would be located on a higher ground level due to the levels change of Stanford Drive. However, these properties have been designed to be bungalows in design (plots 1 and 2) which step up the street. These dwellings would not face directly onto the properties on Hawes Lane and private rear amenity space would be screened by 1.8m close boarded fence. Furthermore, the dwellings achieve the required 14 metre separation distance required between a windowed rear elevation and a side facing gable wall. The only window



proposed in this side elevation would serve a shower room. On this basis, I do not consider a significant loss of privacy would occur. No breach of the 45-degree code would take place from the front and rear habitable rooms of No. 38 Hawes Lane and Plot 3. It is noted No.38 has a side facing window serving a non-habitable room on the boundary with the application site. This is within a single storey side extension which contains doors to the front and rear. Plot 3 has been designed to be set off this elevation by 4.34 metres to reduce impact. A car parking space for Plot 3 would be located in close proximity to this window. However, as members of the public can currently walk directly past this window across the grassed area, I do not consider a significant loss of privacy would occur. On the basis of the above, I do not consider a significant loss of light and/or outlook, overshadowing or privacy would occur to neighbouring properties to warrant refusal of this application.

13.6 Public visual amenity

It is noted that the redevelopment of the site would result in the loss of a grassed area. However, as stated above the site is not allocated for public open space purposes and instead has been identified as a housing site within the Development Plan. The design of the proposed dwellings is acceptable in appearance and scale and would complement the surrounding area which contains a mixture of property types and styles. Trees lost as a result of the development would be compensated for by a landscaping scheme ensured by condition which would further enhance the development within the street scene. The large trees to be retained on site would be protected by root protection measures.

13.7 Layout and density of building

Urban Design have raised no objections to the application subject to minor design amendments. The proposed development complies with the minimum standards for internal and external amenity space as identified within the councils Revised Residential Design Guide SPD 2014. The appearance and layout of the scheme is therefore satisfactory, and the scheme meets the aspirations of design policy.



13.8 Design, appearance and materials

The design and appearance of the proposed development is acceptable with the properties predominantly being two storeys in height and containing a mixture of designs. The development therefore complies with design policies ENV3 (Design Quality) of the Black Country Core Strategy and SAD EOS9 (Urban Design Principles) of the Site Allocations and Delivery Development Plan Document. An external materials condition has been included within the recommendation.

14 Alternative Options

14.1 Refusal of the application is an option if there are material planning reasons for doing so. In my opinion the proposal is complaint with relevant polices and there are no material considerations that would justify refusal.

15 Implications

Resources:	When a planning application is refused the applicant
Resources.	
	has a right of appeal to the Planning Inspectorate, and
	they can make a claim for costs against the Council.
Legal and	This application is submitted under the Town and
Governance:	Country Planning Act 1990.
Risk:	None.
Equality:	There are no equality issues arising from this proposal
	and therefore an equality impact assessment has not
	been carried out.
Health and	None.
Wellbeing:	
Social Value	None.

16. Appendices

Site Plan






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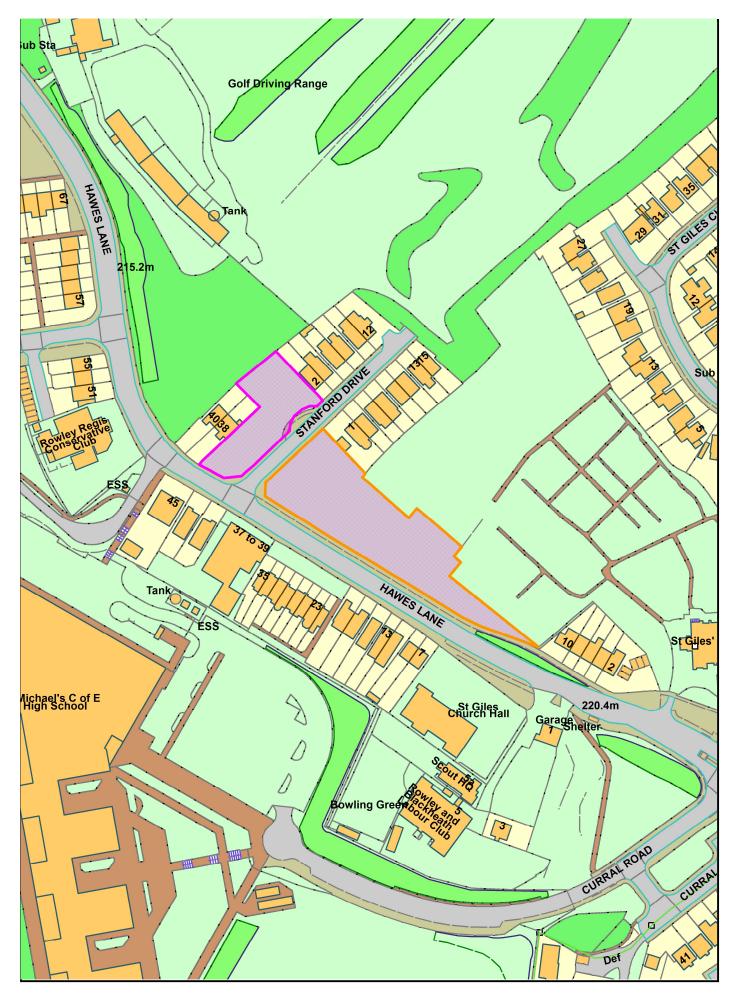
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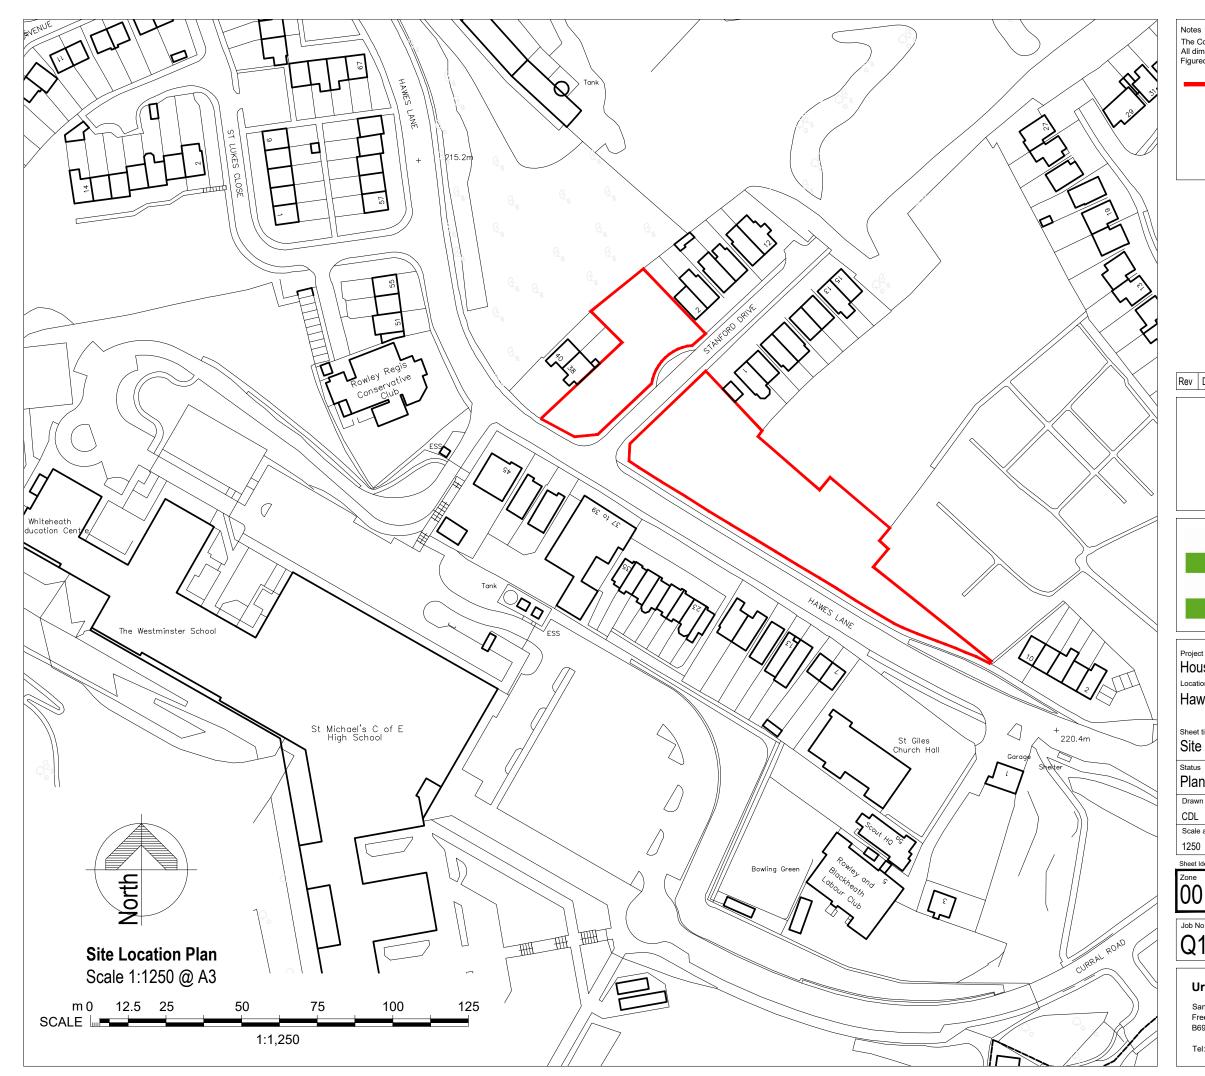
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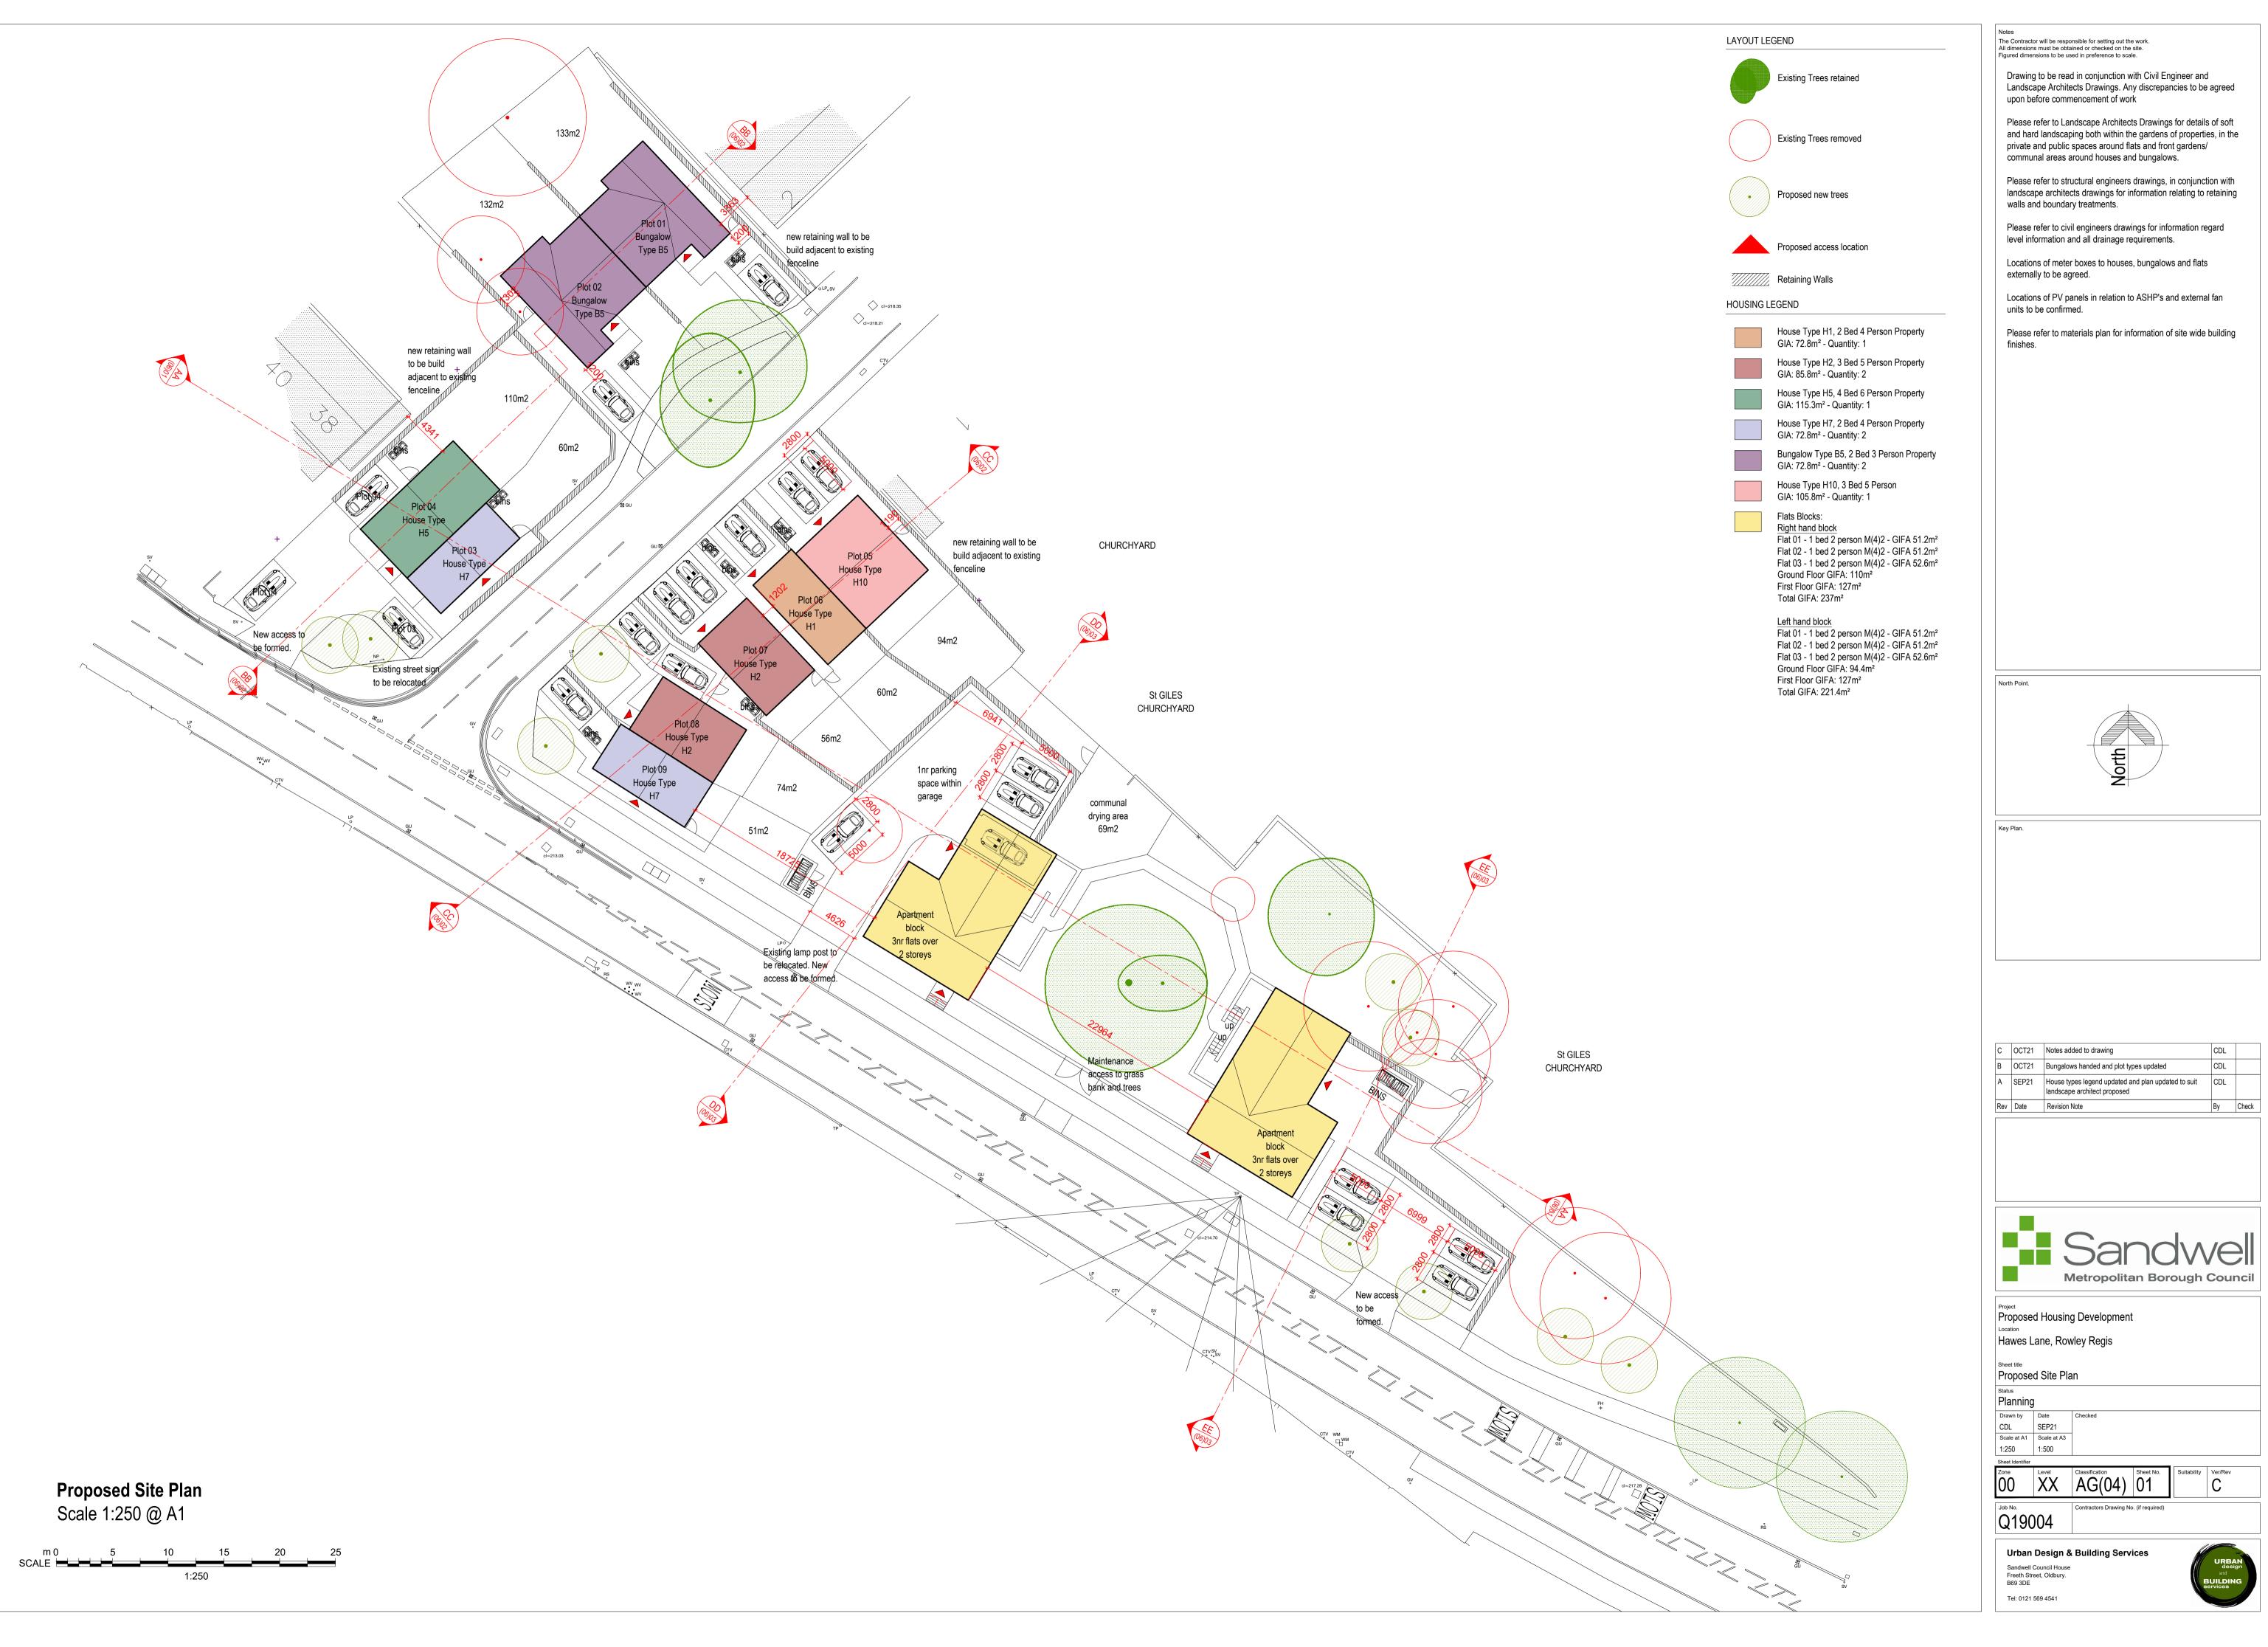




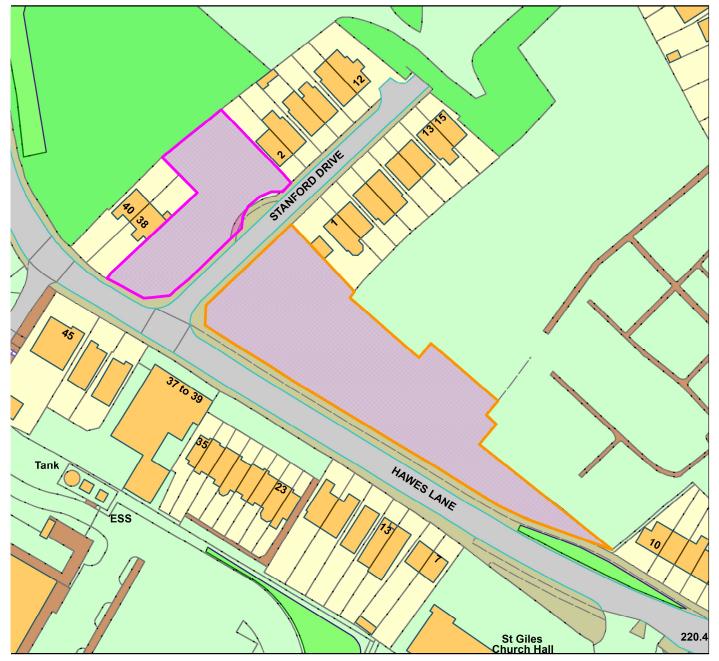


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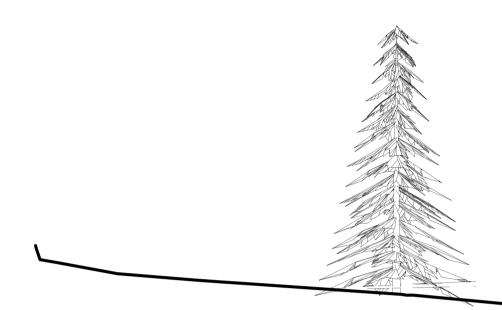
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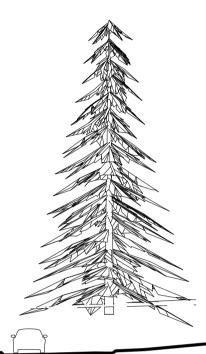
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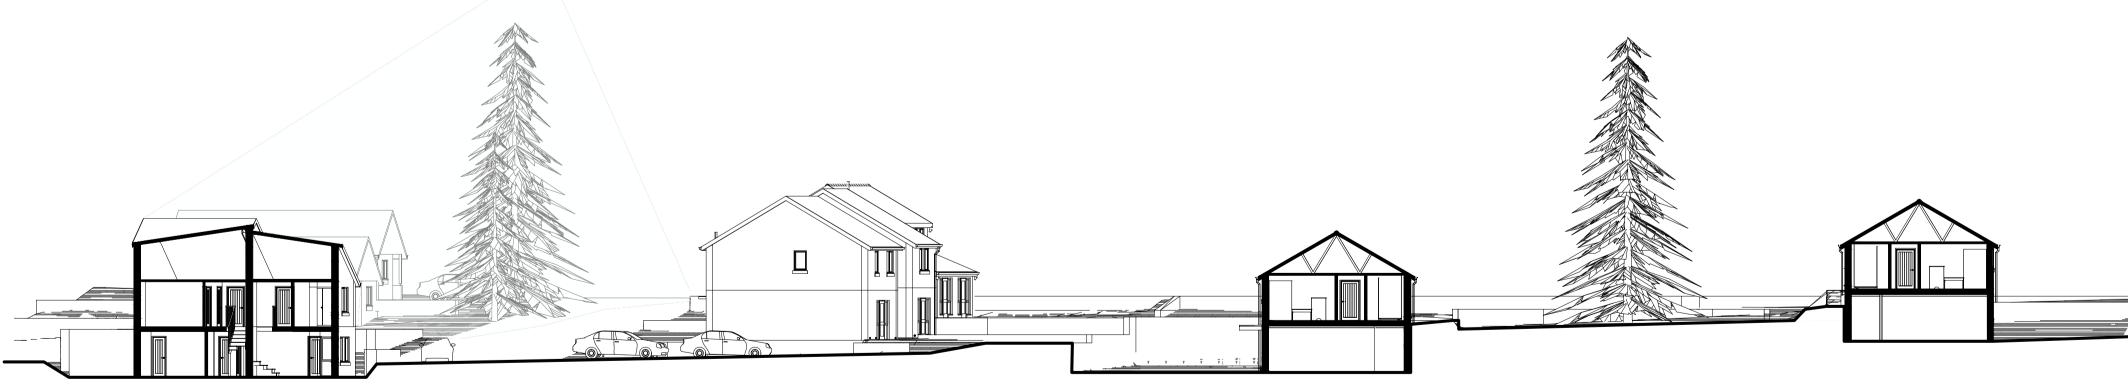


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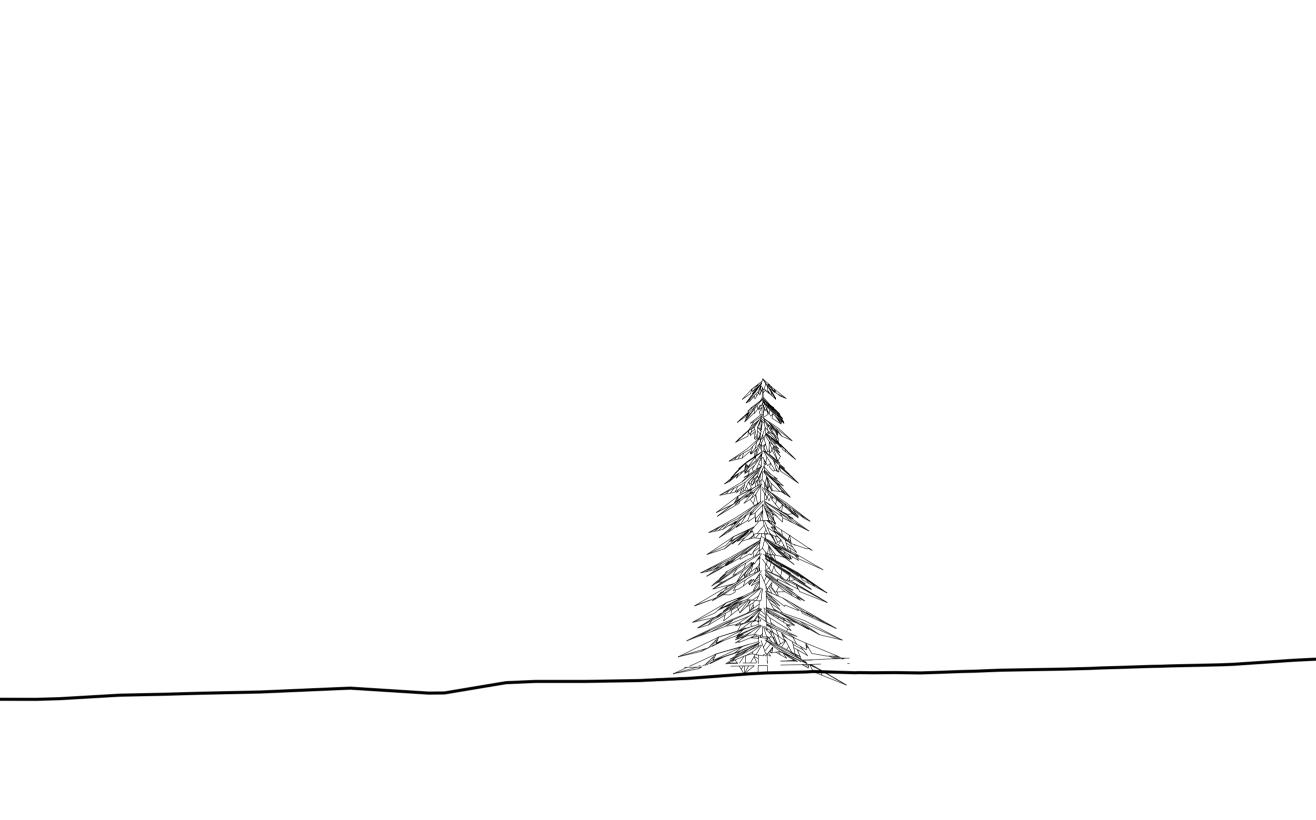
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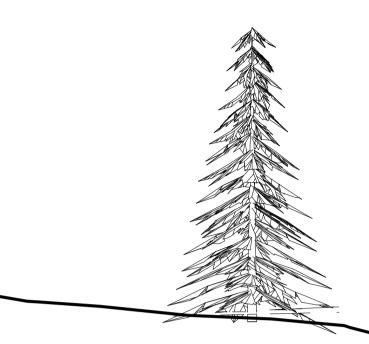
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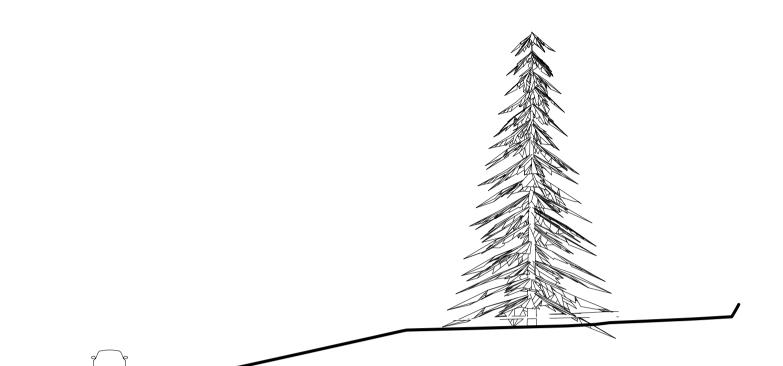
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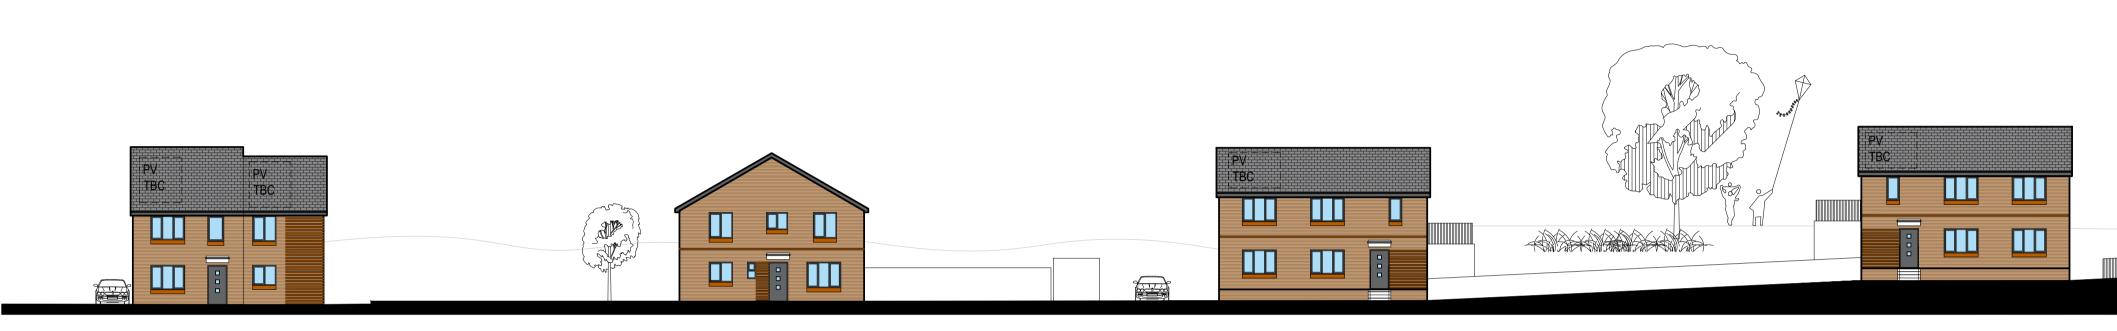
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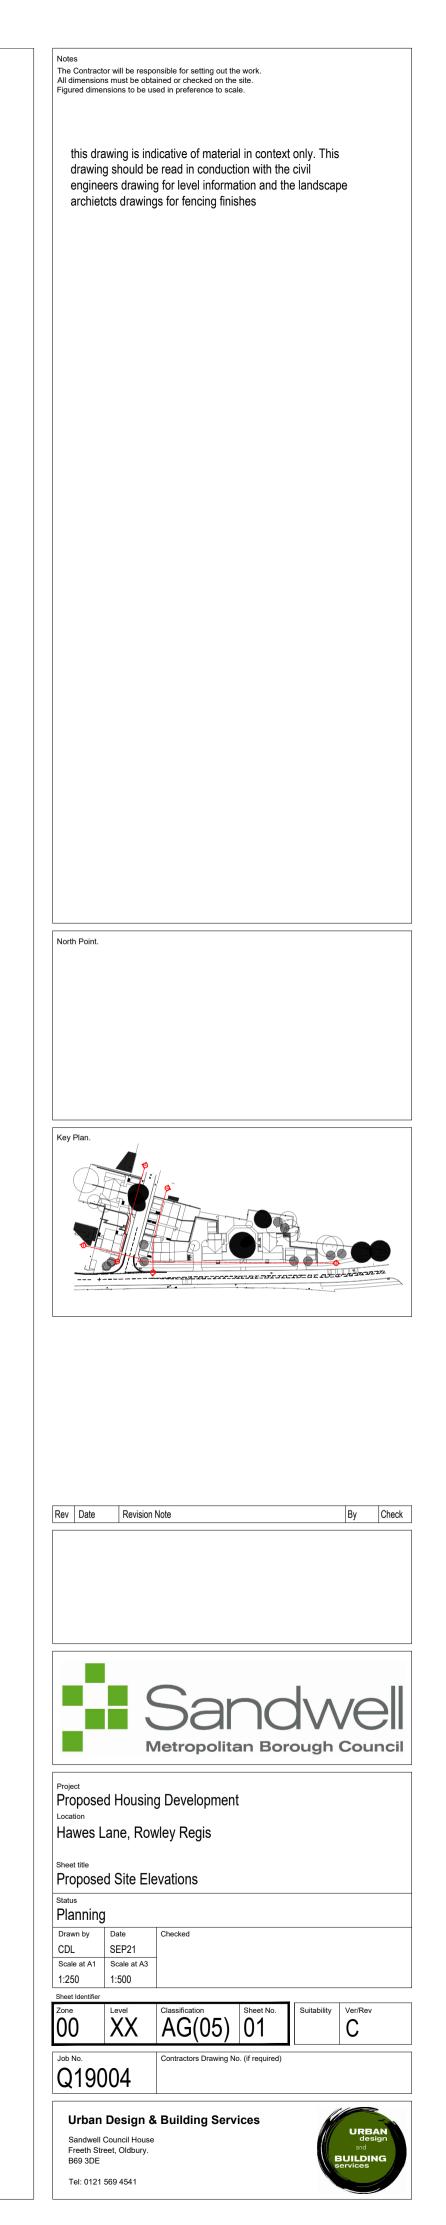
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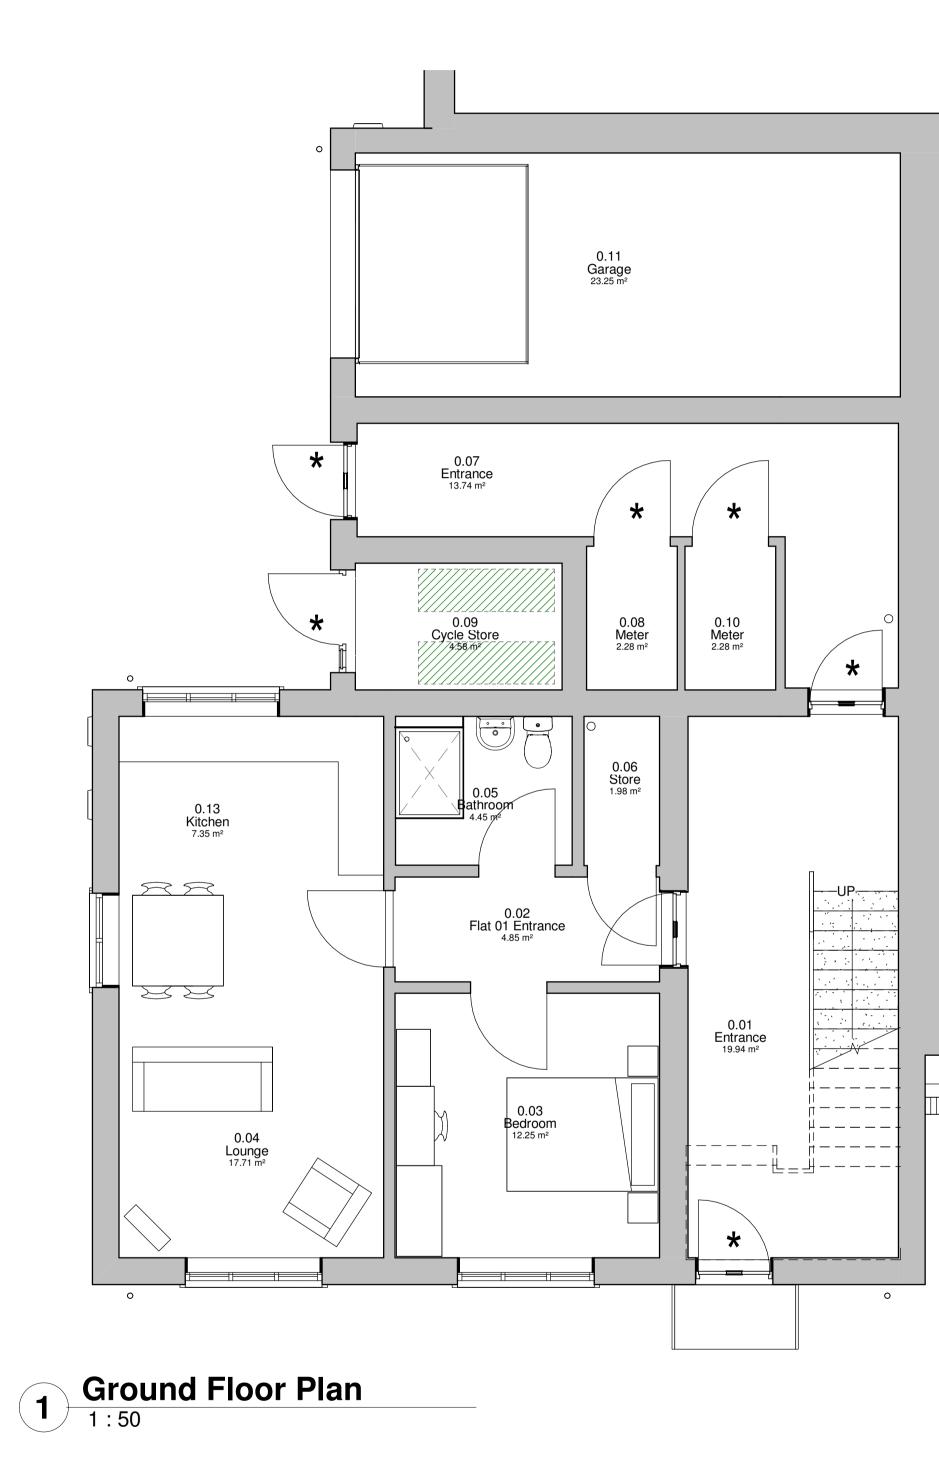
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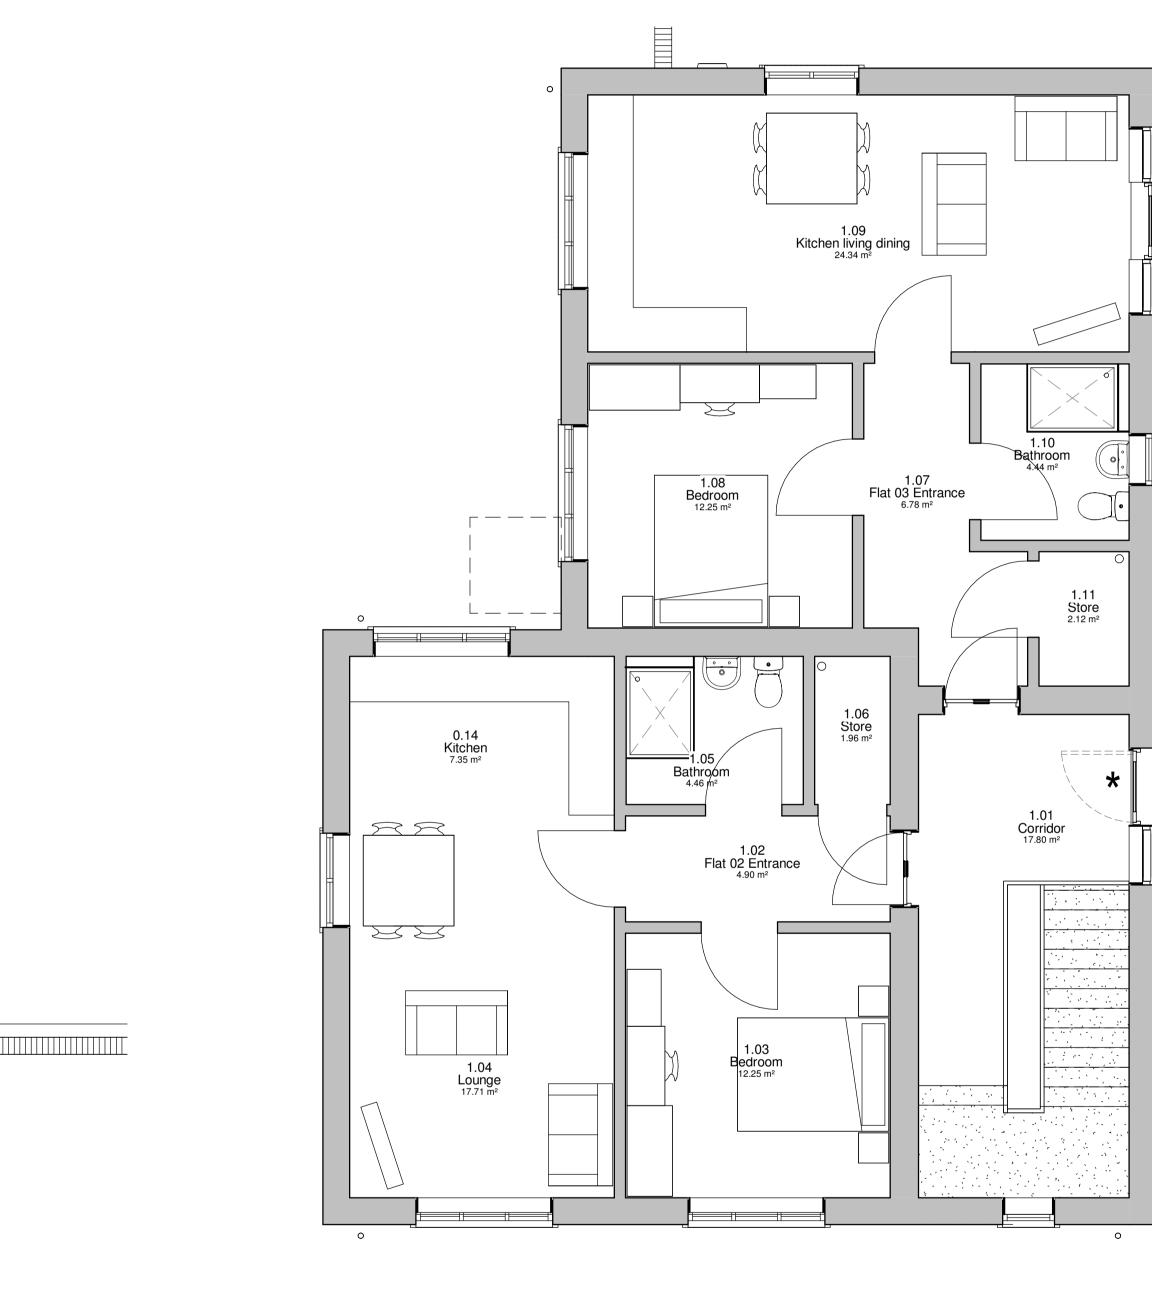


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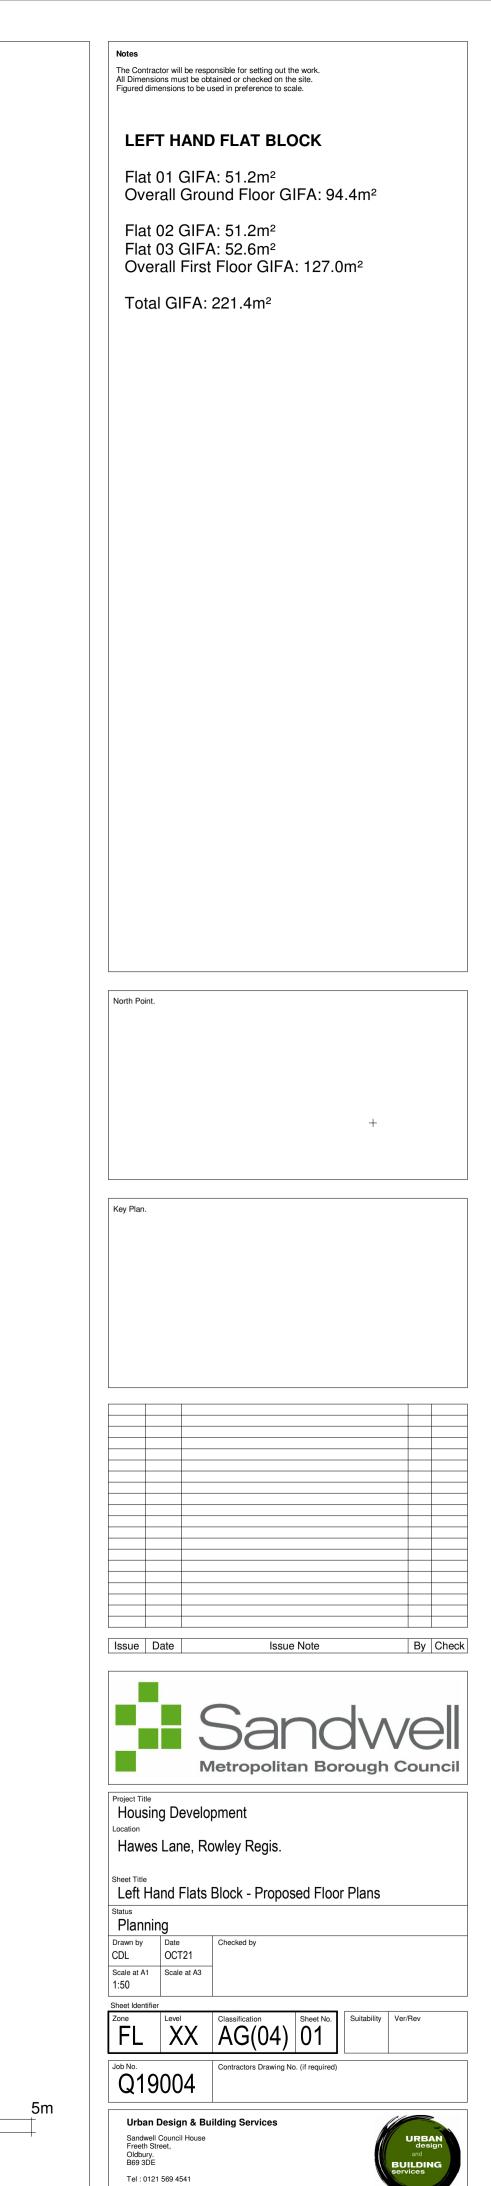







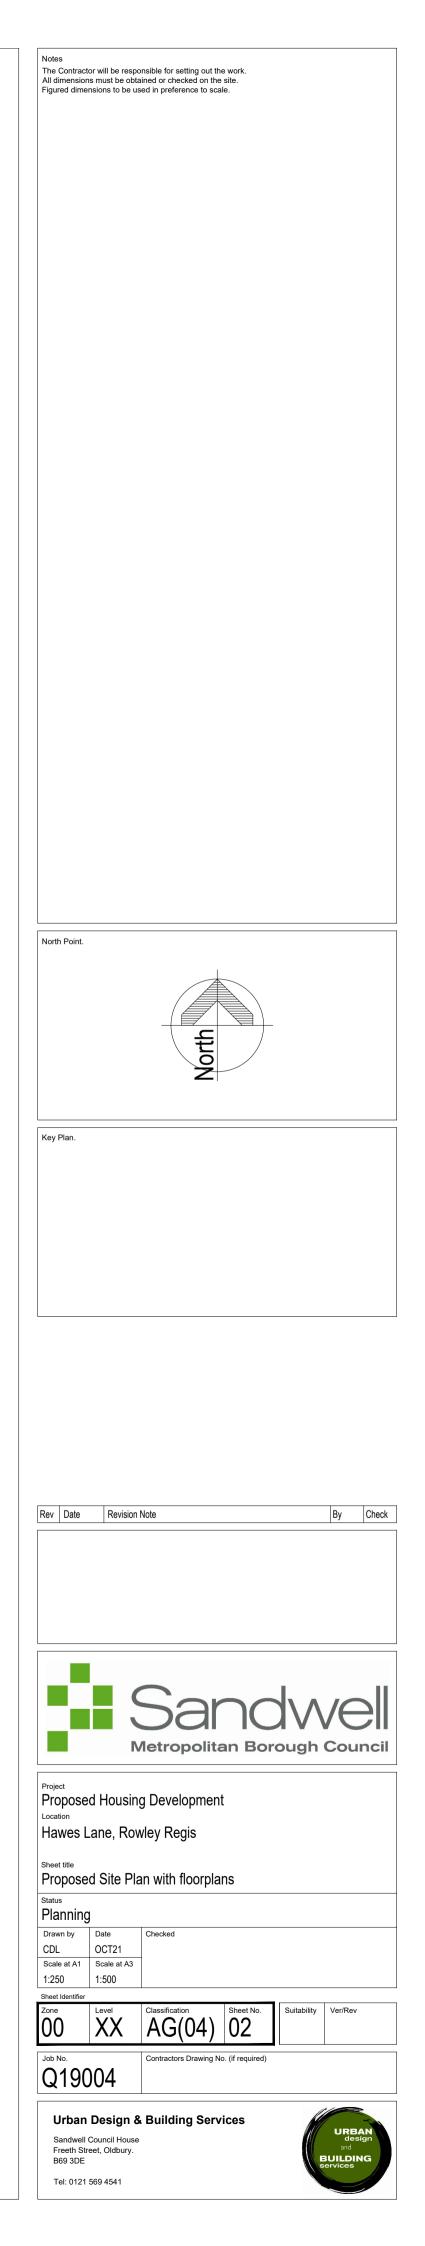








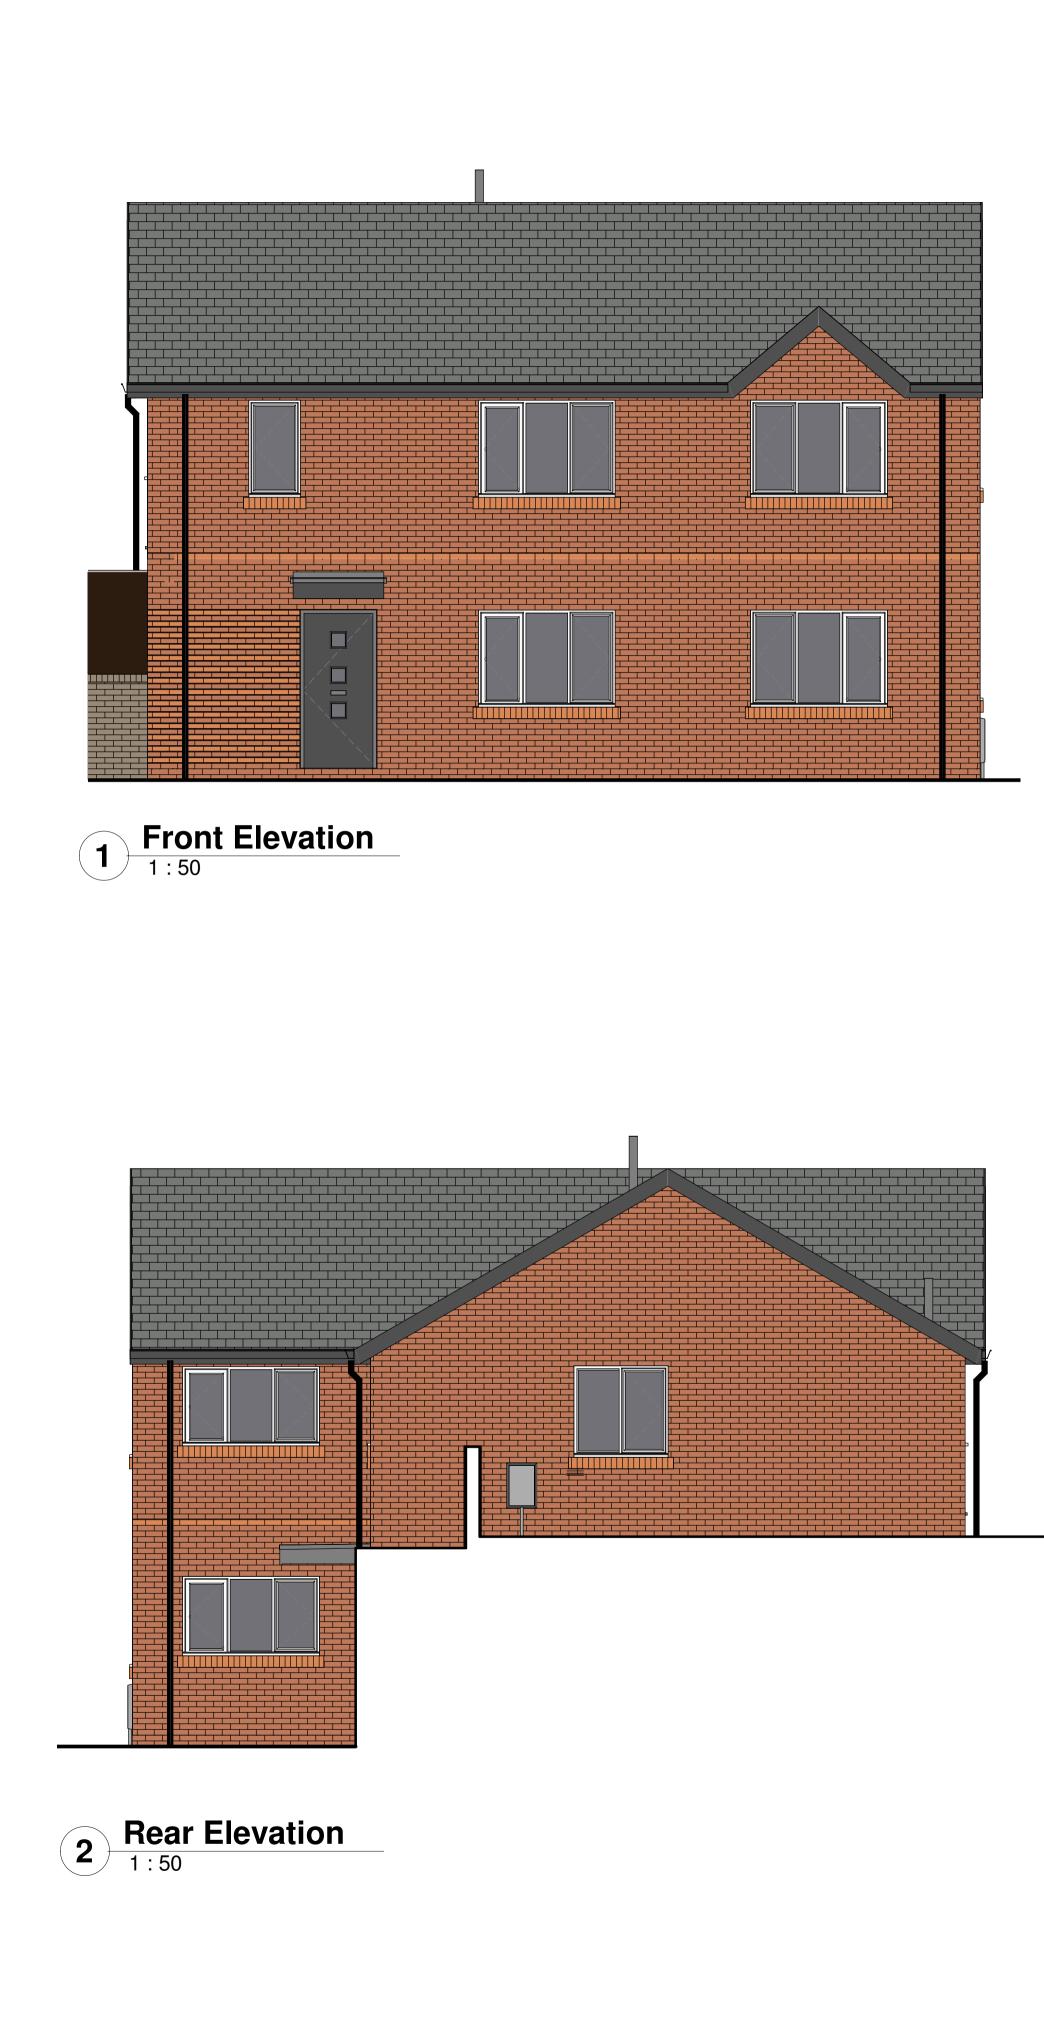








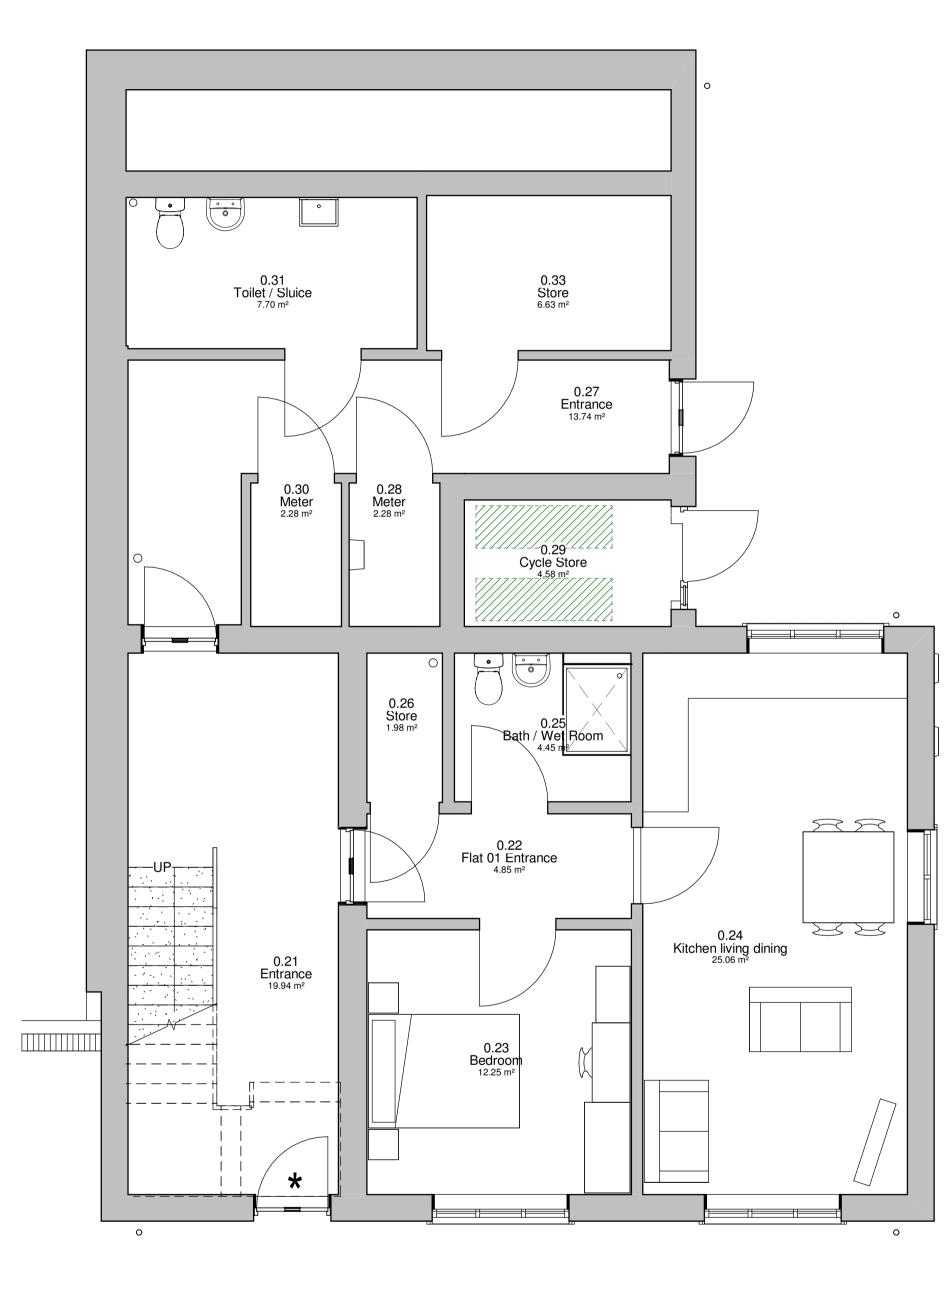




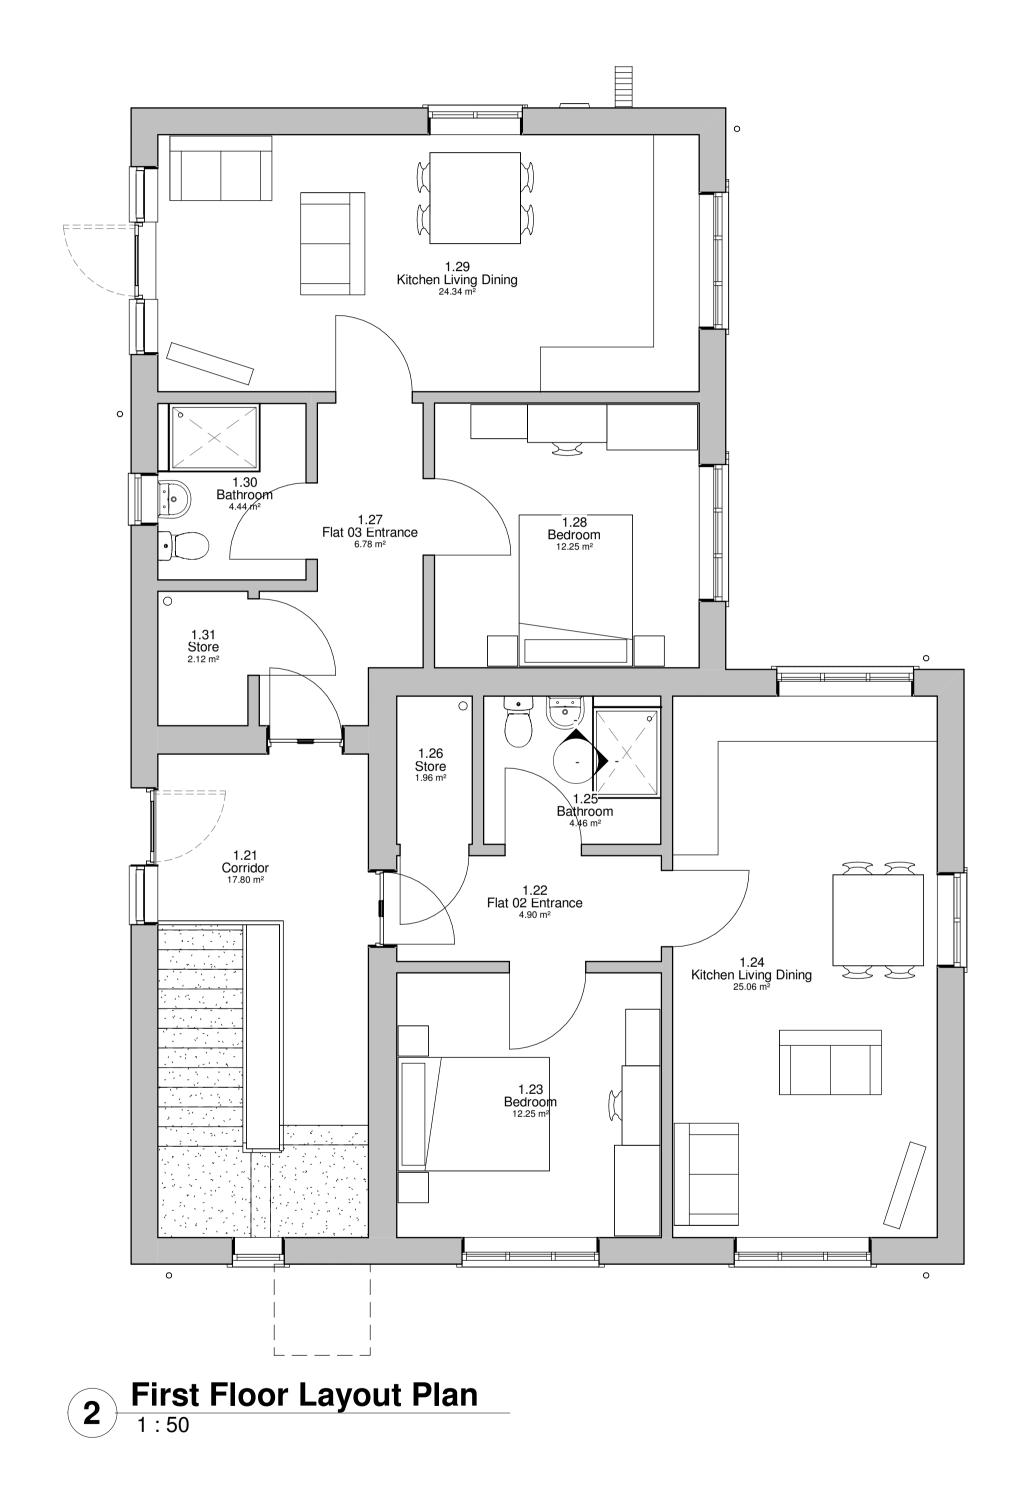


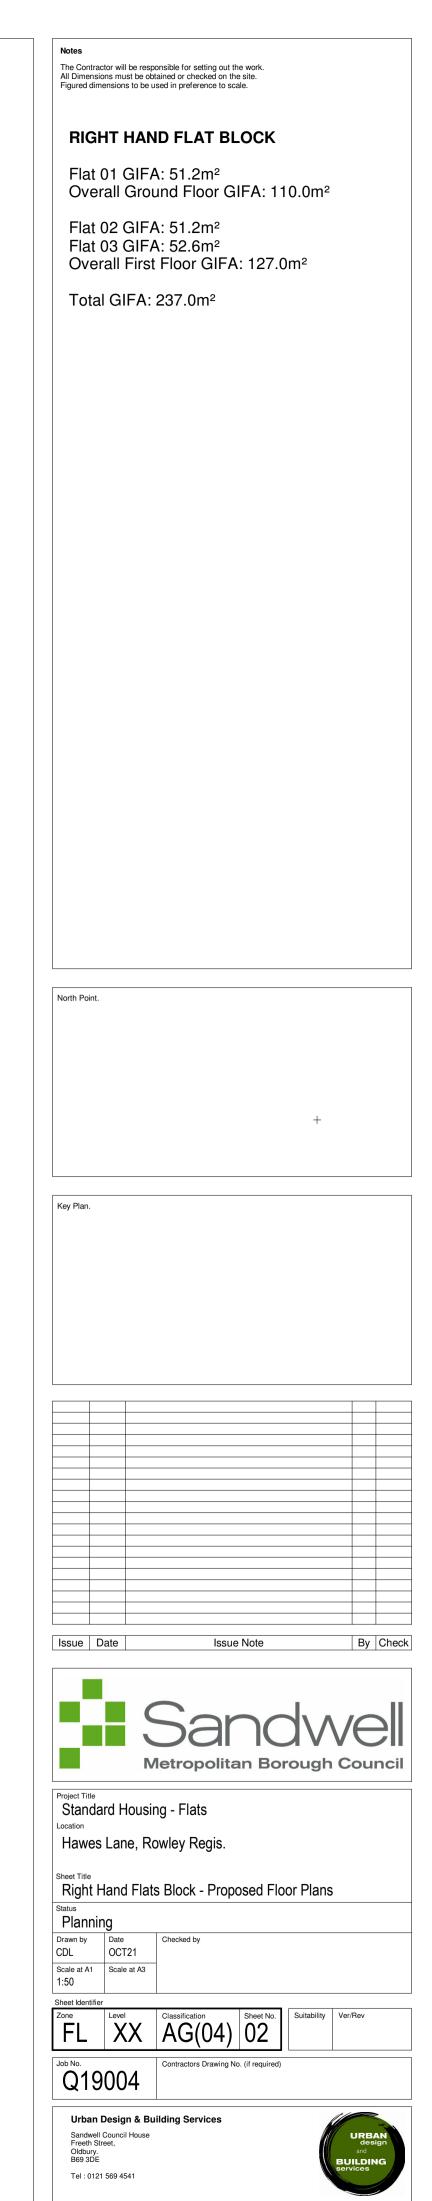

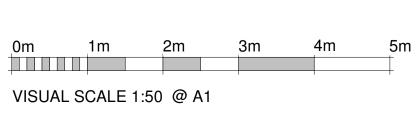


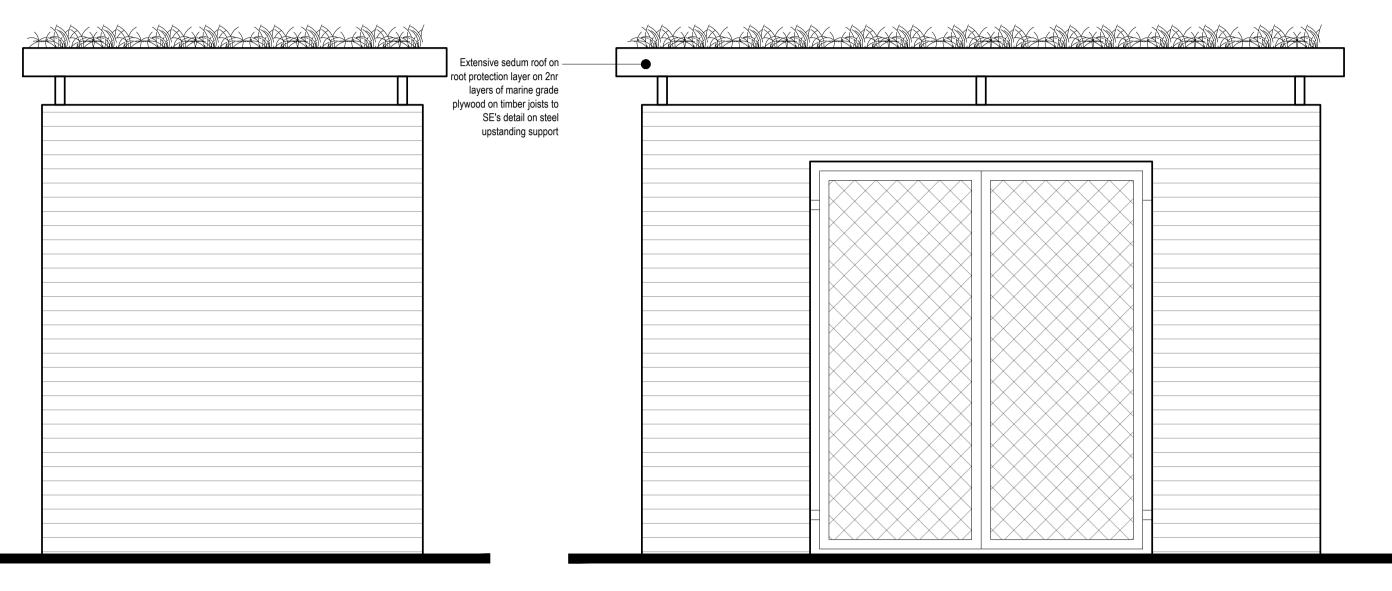

Elevation 01 Scale 1:20

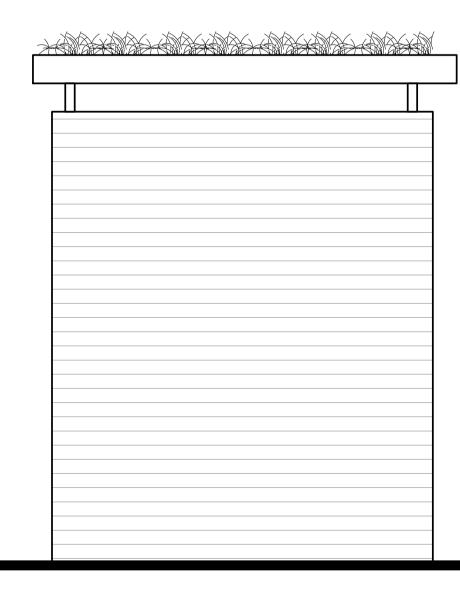

Elevation 03 Scale 1:20 Elevation 02 Scale 1:20

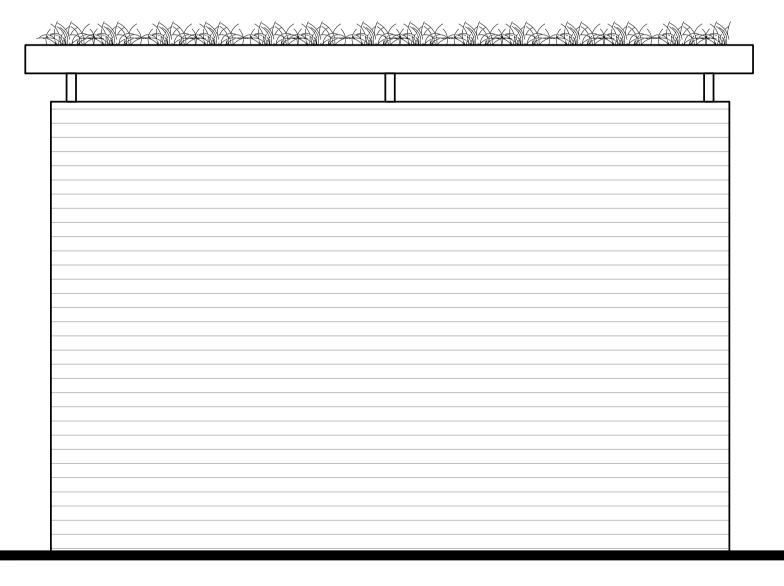



Elevation 04 Scale 1:20


	Notes The Contractor will be responsible for setting out the work. All dimensions must be obtained or checked on the site.
	Figured dimensions to be used in preference to scale.
	North Point.
	Key Plan.
	Rev Date Revision Note By Check
	Sandwell
	Metropolitan Borough Council
	Project New Housing Development
	Location Hawes Lane, Rowley Regis
	Sheet title Bin Store Elevations
	Status Planning
	Drawn by Date Checked CDL NOV21 Scale at A1 Scale at A3
	1:20 1:40 Sheet Identifier
	Zone Level Classification Sheet No. FL XX AG(05) 08
	Job No. Contractors Drawing No. (if required)
	Urban Design & Building Services
.6 1.8 2.0	Sandwell Council House design
	B69 3DE Tel: 0121 569 4541

0.4	0.6	0.8	1.0	1.2	1.4	1.6	1.8	2.0
			1:20					

	\checkmark	\checkmark				
		\checkmark	\checkmark		\checkmark	
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		\checkmark	\checkmark		\checkmark	
m roof on	\checkmark	\checkmark				
er on 2nr ine grade		\checkmark	\checkmark		\checkmark	
er joists to il on steel g support	\checkmark	\checkmark				
apport		\checkmark	\checkmark		\checkmark	
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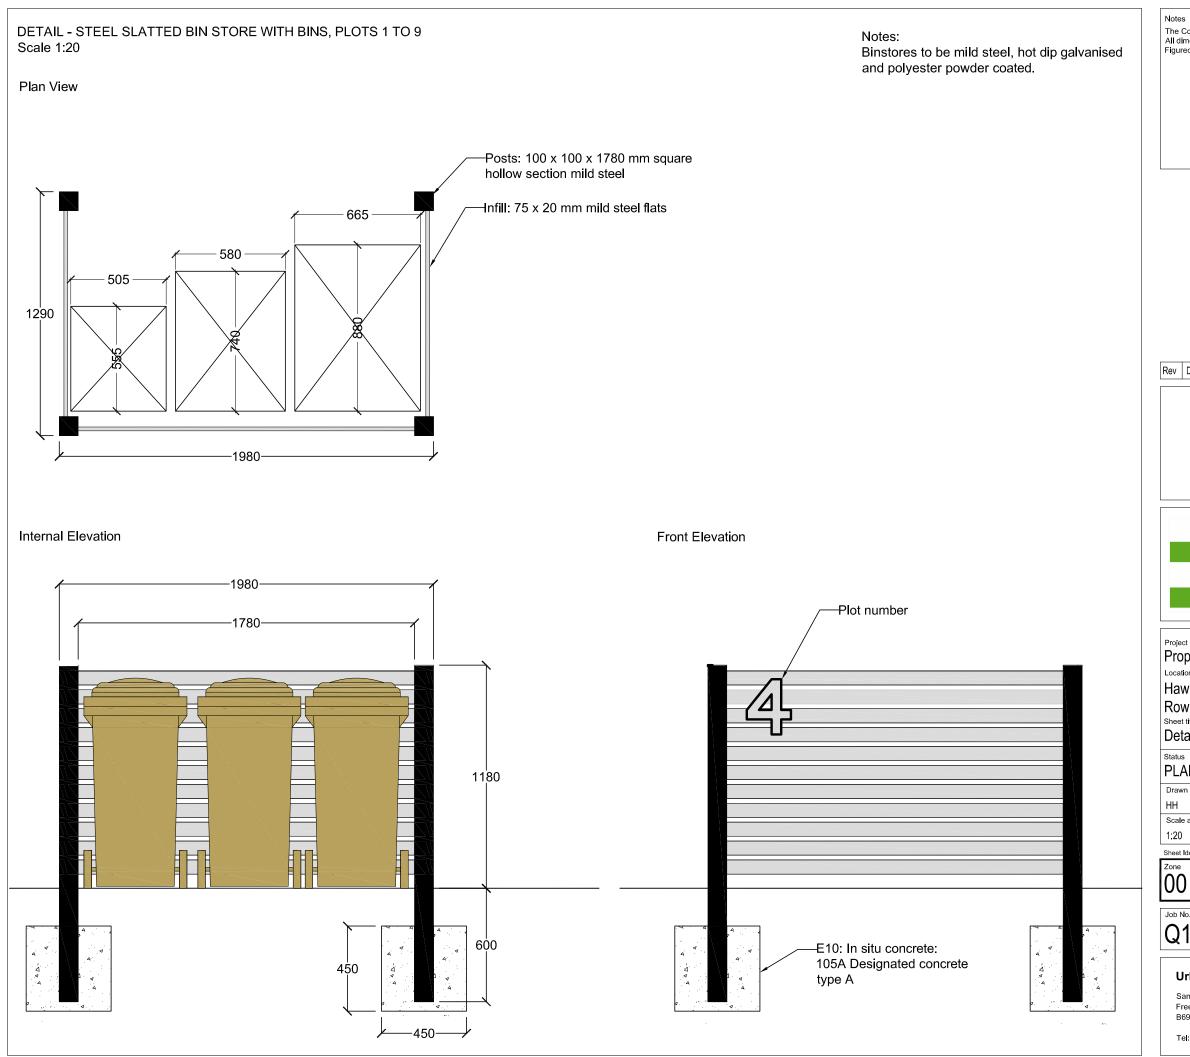


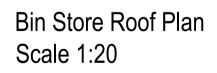mm 0 100 SCALE

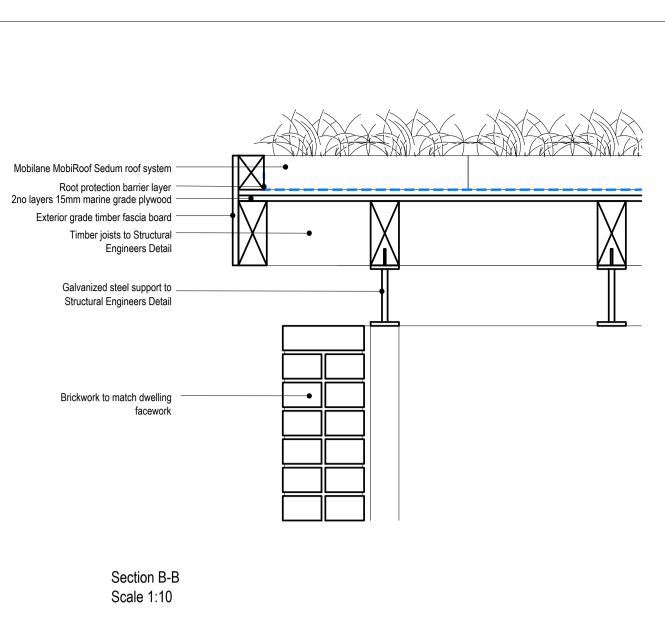m 0 0.2 SCALE

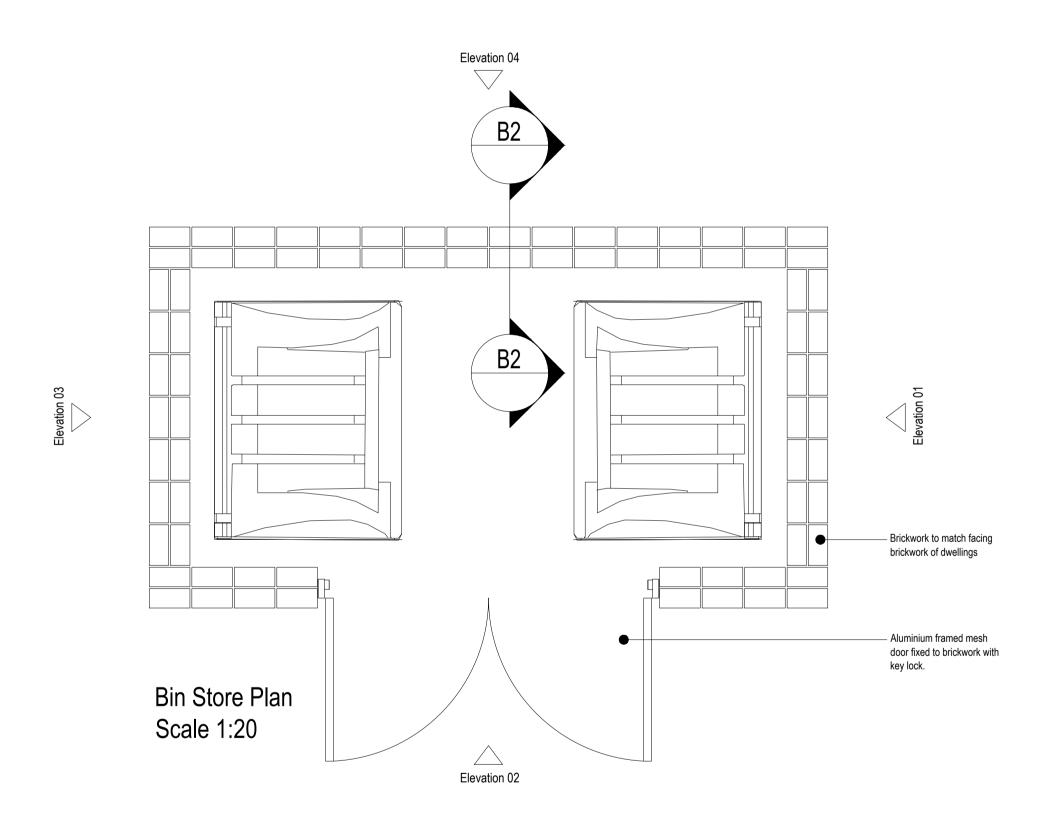North Point	t.			
Key Plan.				
Rev Date	Revisio	n Note		By Cł
		Sa	nd	Ne
		Metropolit		
Location		evelopment		
Sheet title	Lane, Ro ore Plans	owley Regis		
_{Status} Plannir	ng			
Drawn by CDL Scale at A1	Date NOV21 Scale at A3	Checked		
Varies Sheet Identifie Zone	Level	Classification AG(04)	Sheet No. Suit	ability Ver/Rev
FL Job No.		AG(04)		
Q19	004			
Urba	n Design	& Building Serv	vices	


20	00 3	00 4	00 50	00 60	0 70	08 00	0 90	0 1000
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0	.4 0	.6 0	.8 1.	.0 1.:	21.	4 1.	6 1.	8 2.0
			1:	20				



The Contractor will be responsible for setting out the work. All dimensions must be obtained or checked on the site. Figured dimensions to be used in preference to scale.

Date	Revision	Note			Ву	Check
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IS ANNI	NG					
wn by le at A3)	Date 10-11-21 Scale at A5	Checked				
t Identifier	Level	Classification L-A(93)	Sheet No.	Suitability	Ver/Rev	
^{№.})04	Contractors Drawing No	o. (if required)			
Sandwell	Design & Council House eet, Oldbury.	Building Servi	ces	B	URB/ desi and UILDIN ervices	

Tel: 0121 569 4541

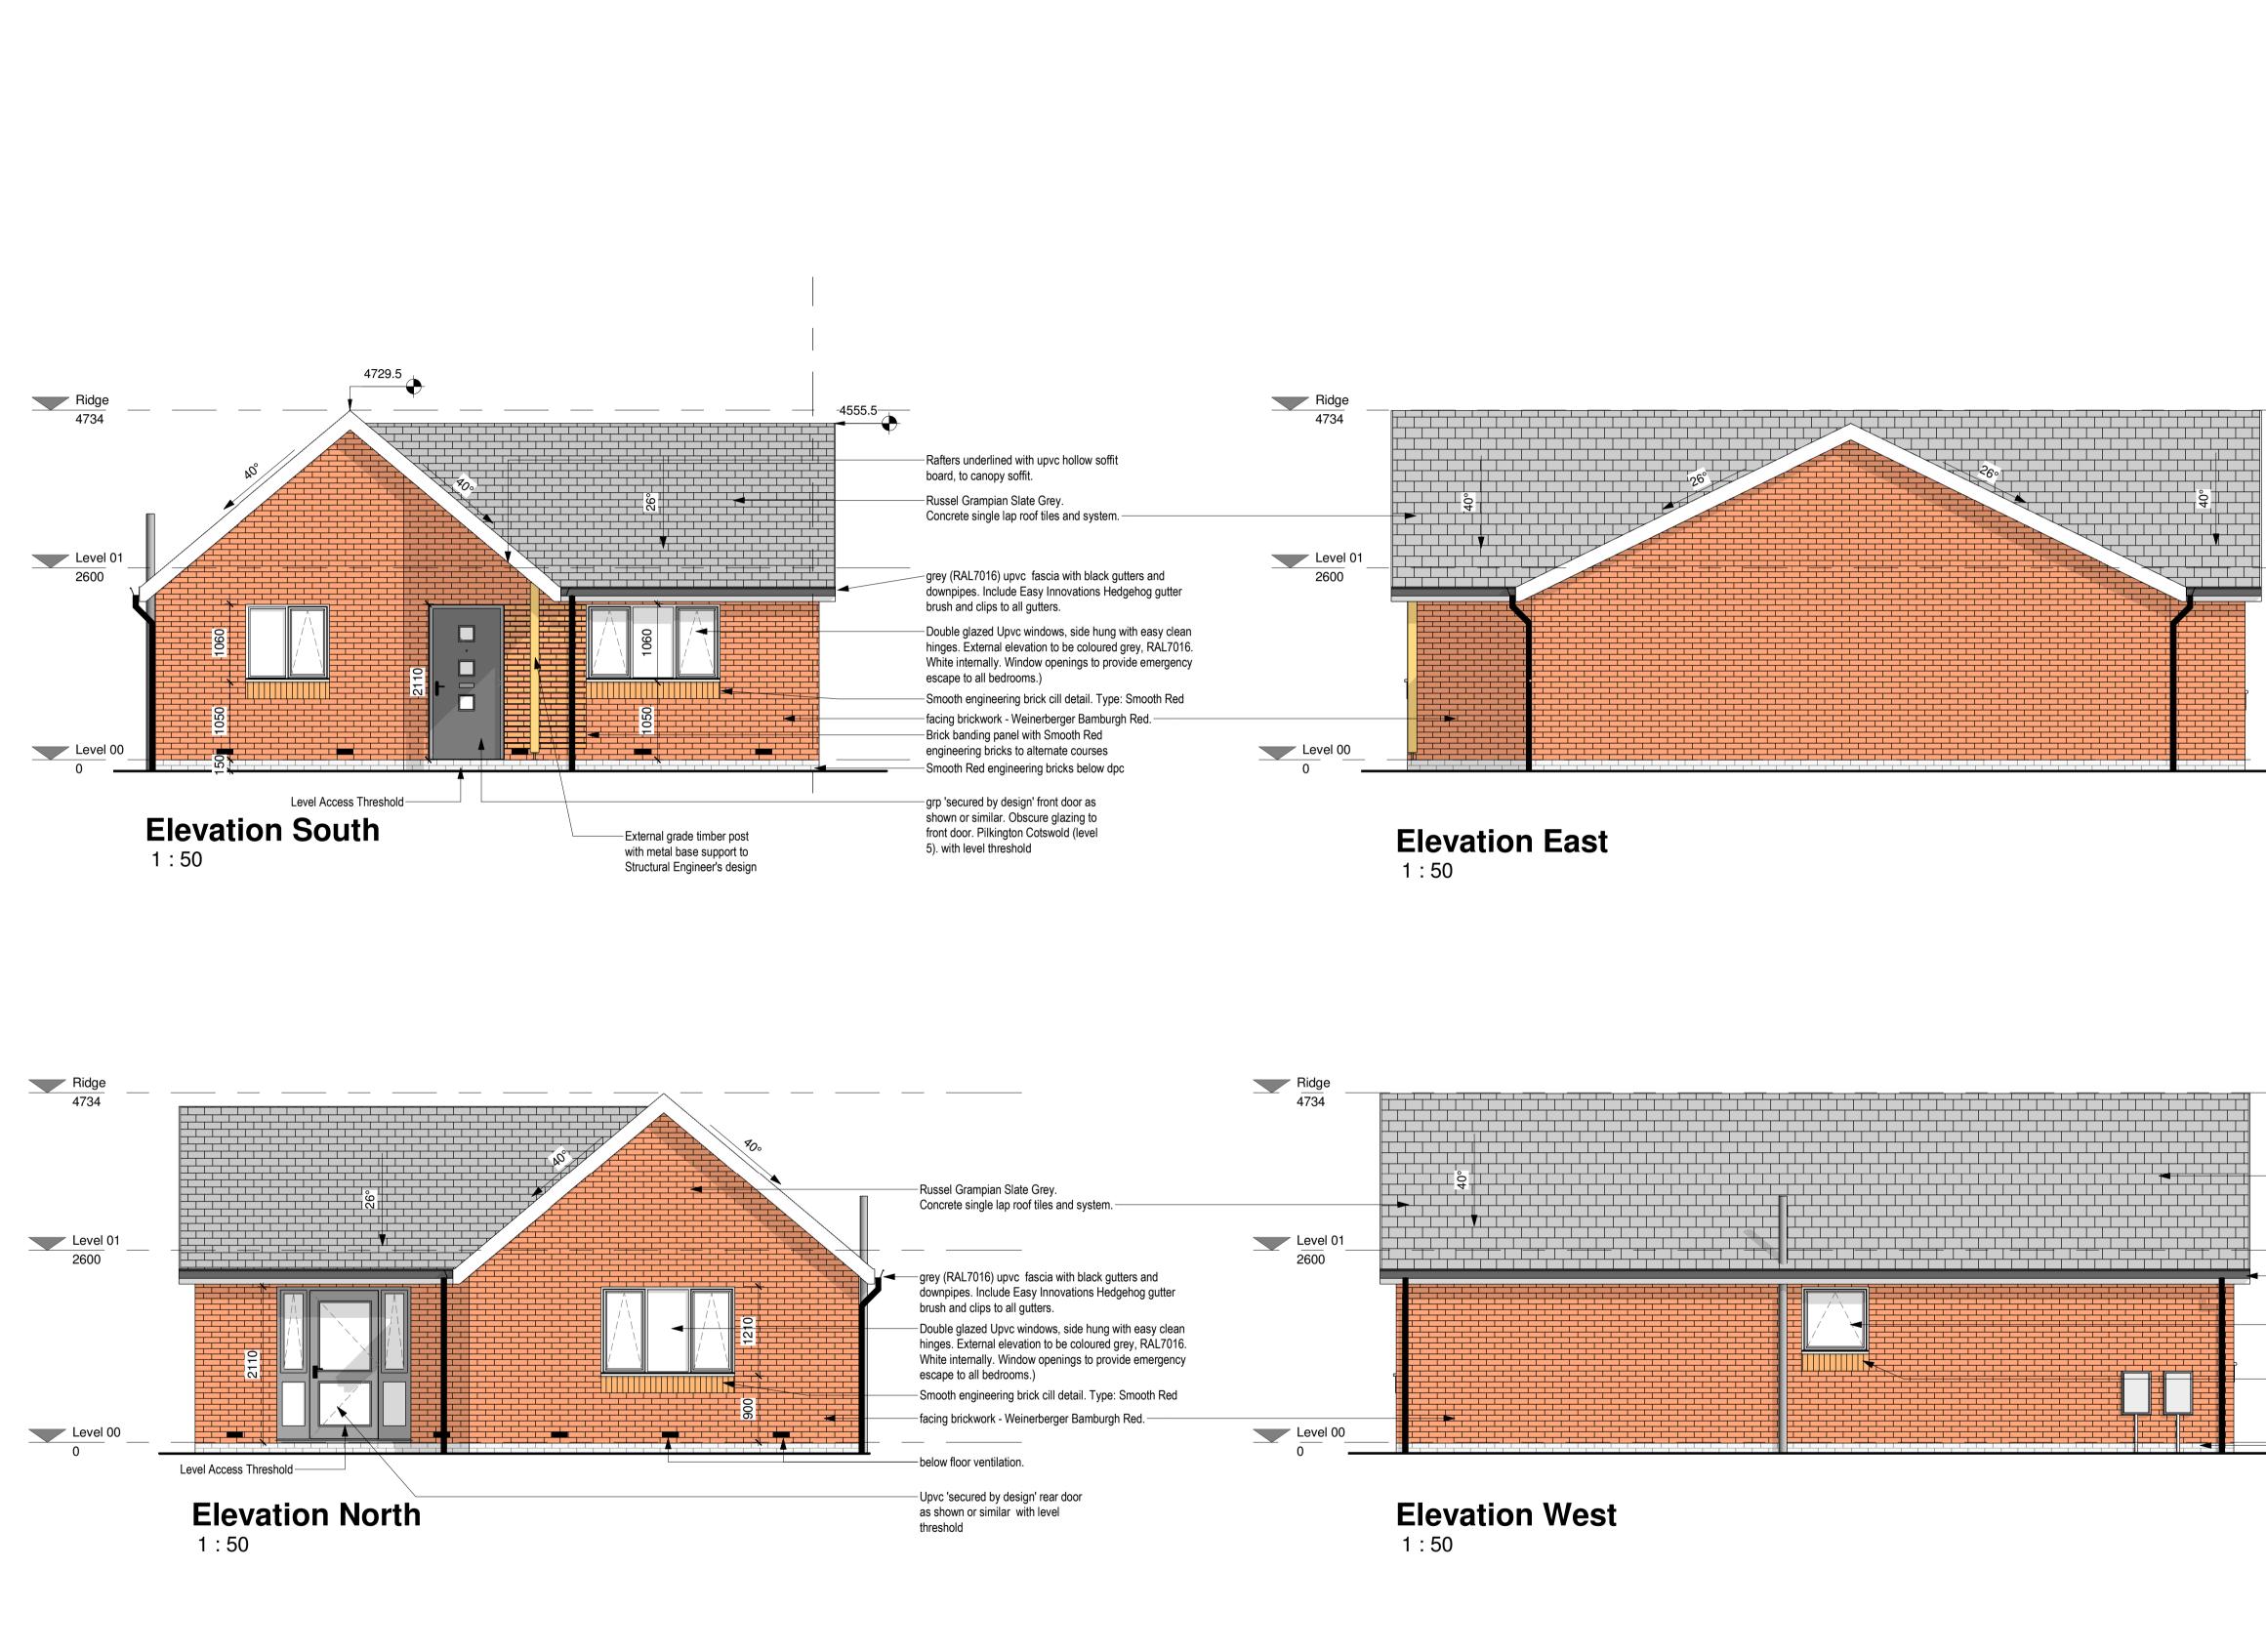



Plots 02, Handed Plot 01

Key Plan.

_____ _____

North Point.

-roofing tiles -colour and texture to be confirmed


grey (RAL7016) upvc_fascia with black gutters and downpipes


 Double glazed Upvc windows, side hung with easy clean hinges. External elevation to be coloured grey, RAL7016.
 White internally. Frosted Glass. -Smooth engineering brick cill detail. Type: Smooth Red

—⁻Smooth Red engineering bricks below dpc





Scale at A1 Scale at A3 1:50 Sheet Identifier ZoneLevelClassificationSheet No.SuitabilityVer/RevB5ZZAG(05)01D1P05 Q19004 Contractors Drawing No. (if required) Urban Design & Building Services Sandwell Council House Freeth Street, Oldbury. B69 3DE Tel : 0121 569 4541

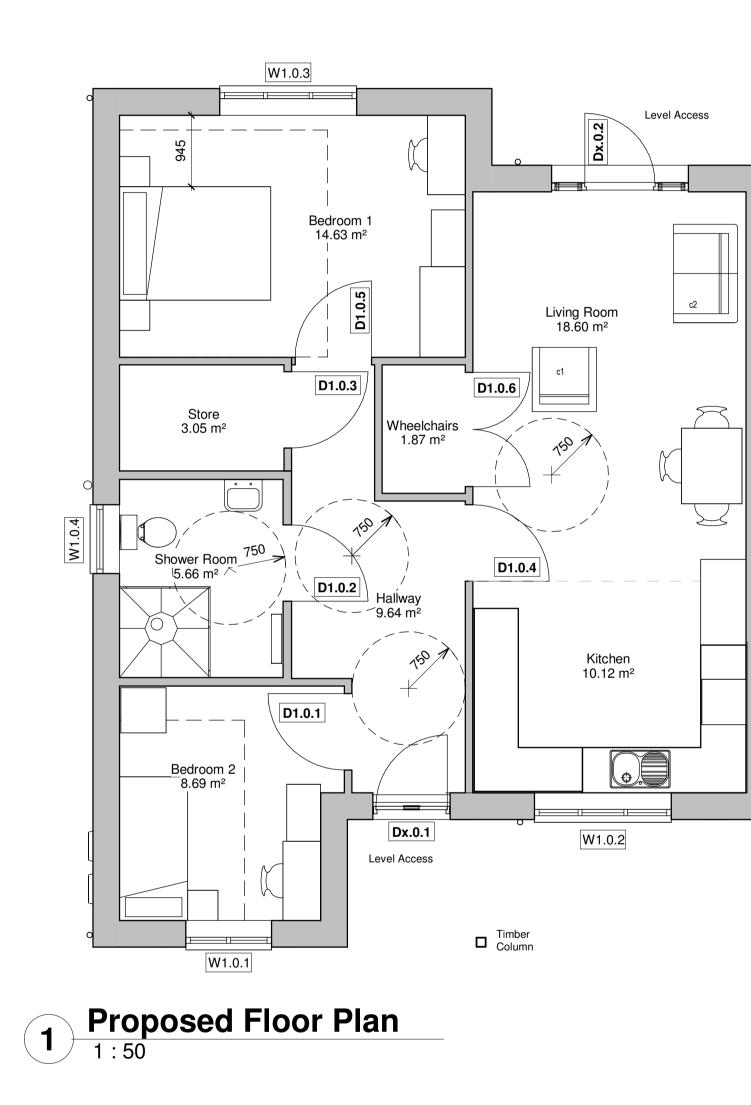


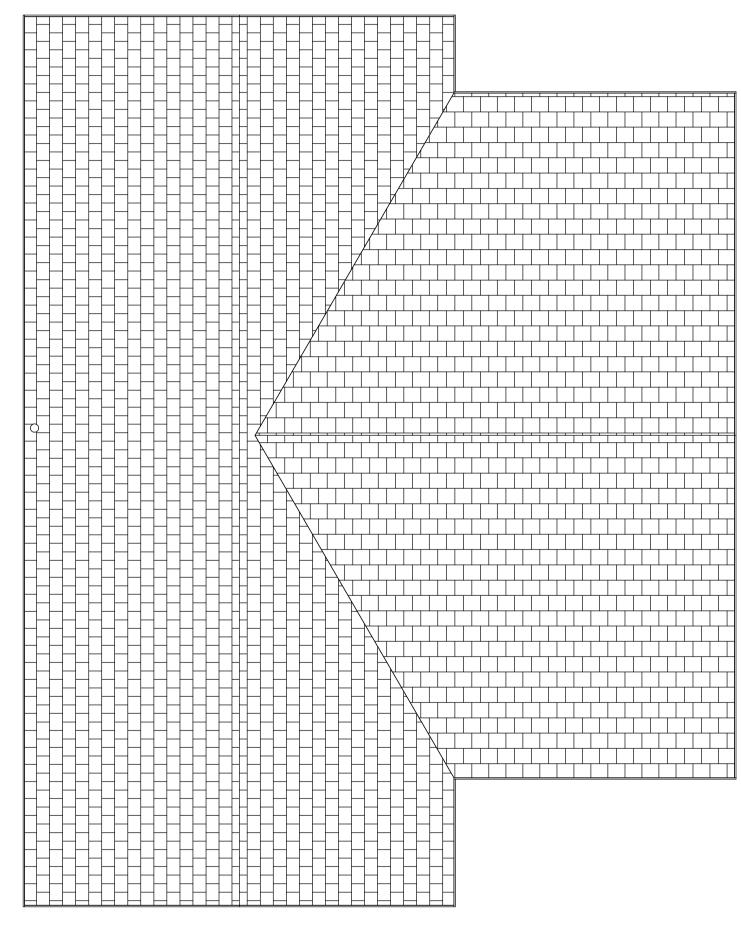



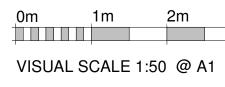

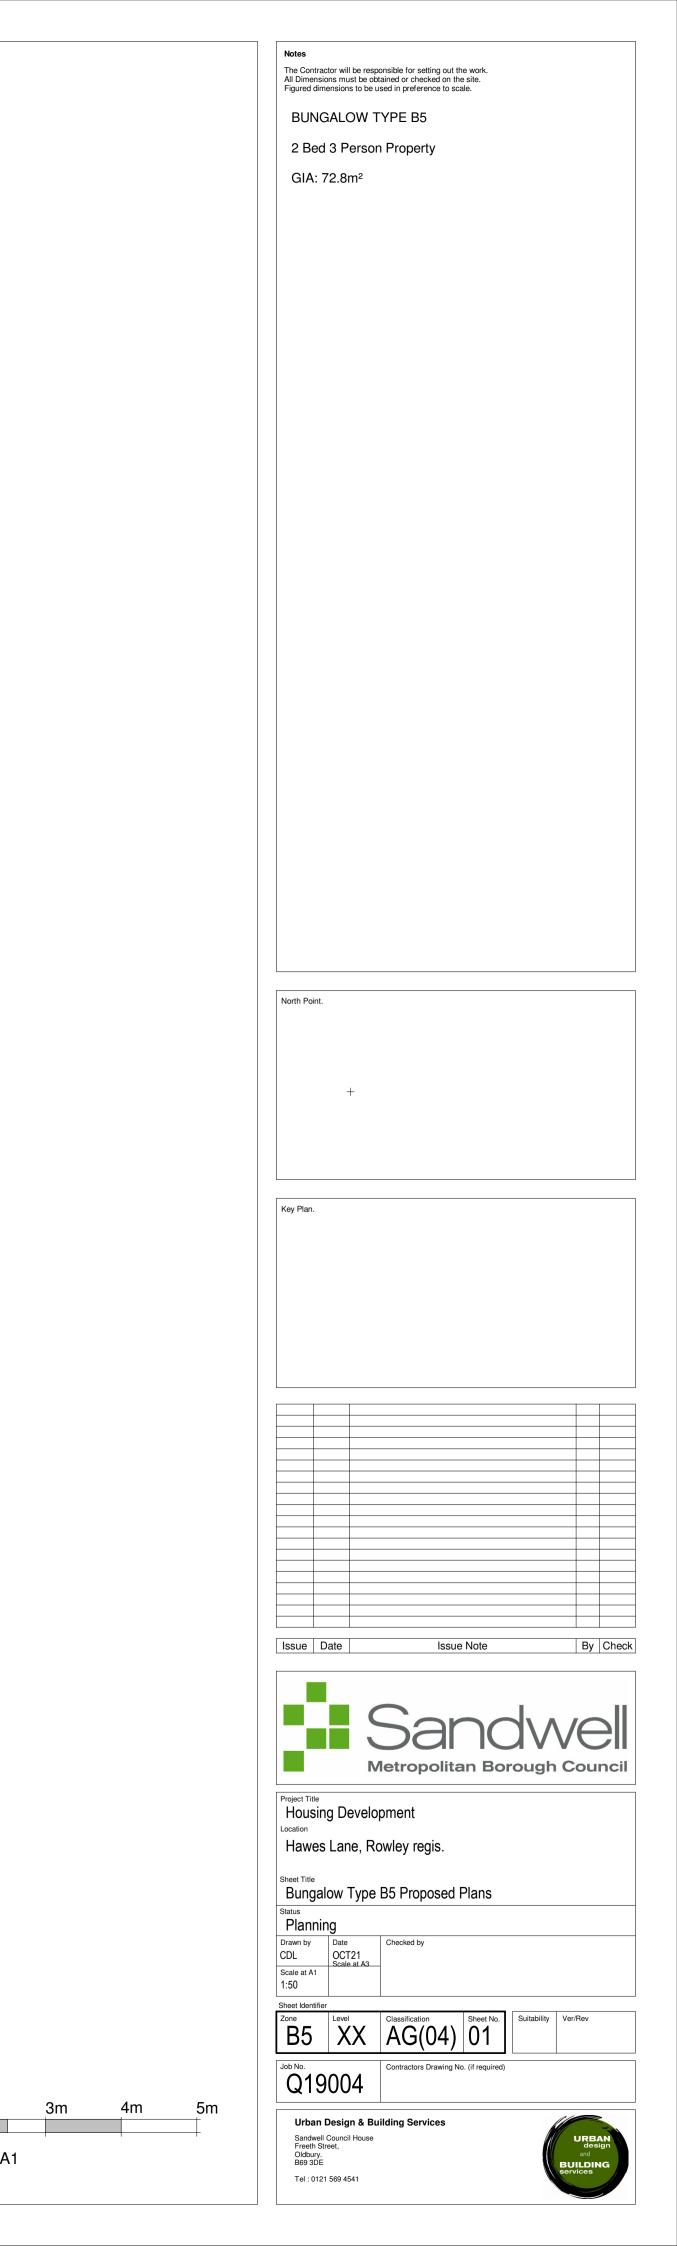


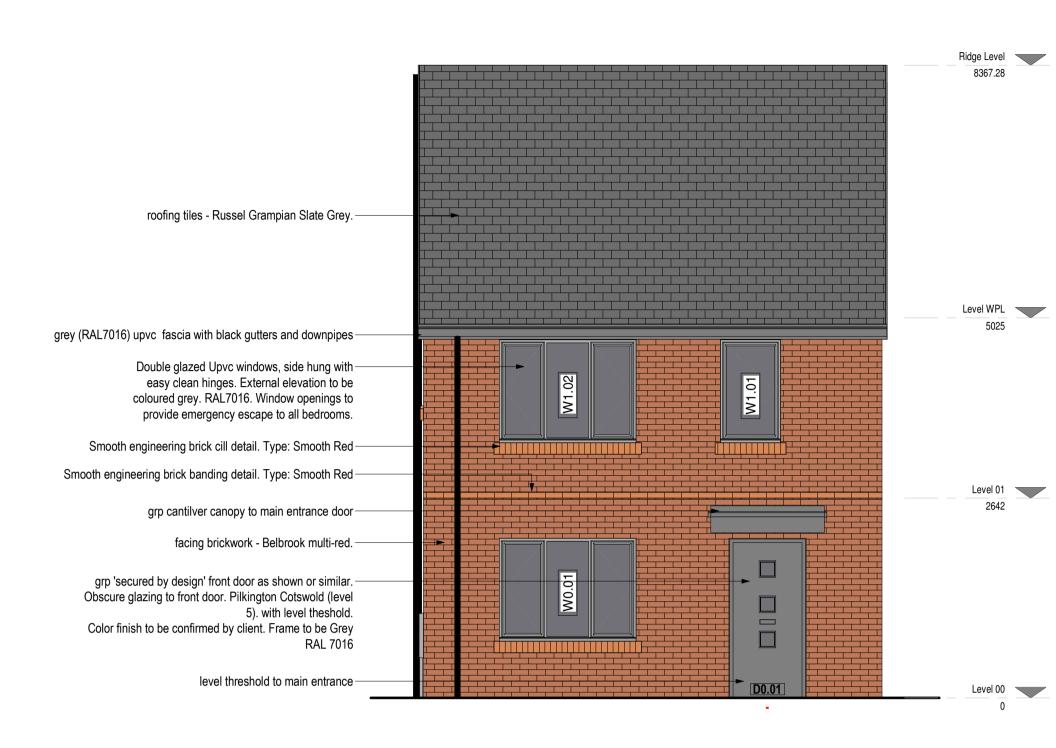









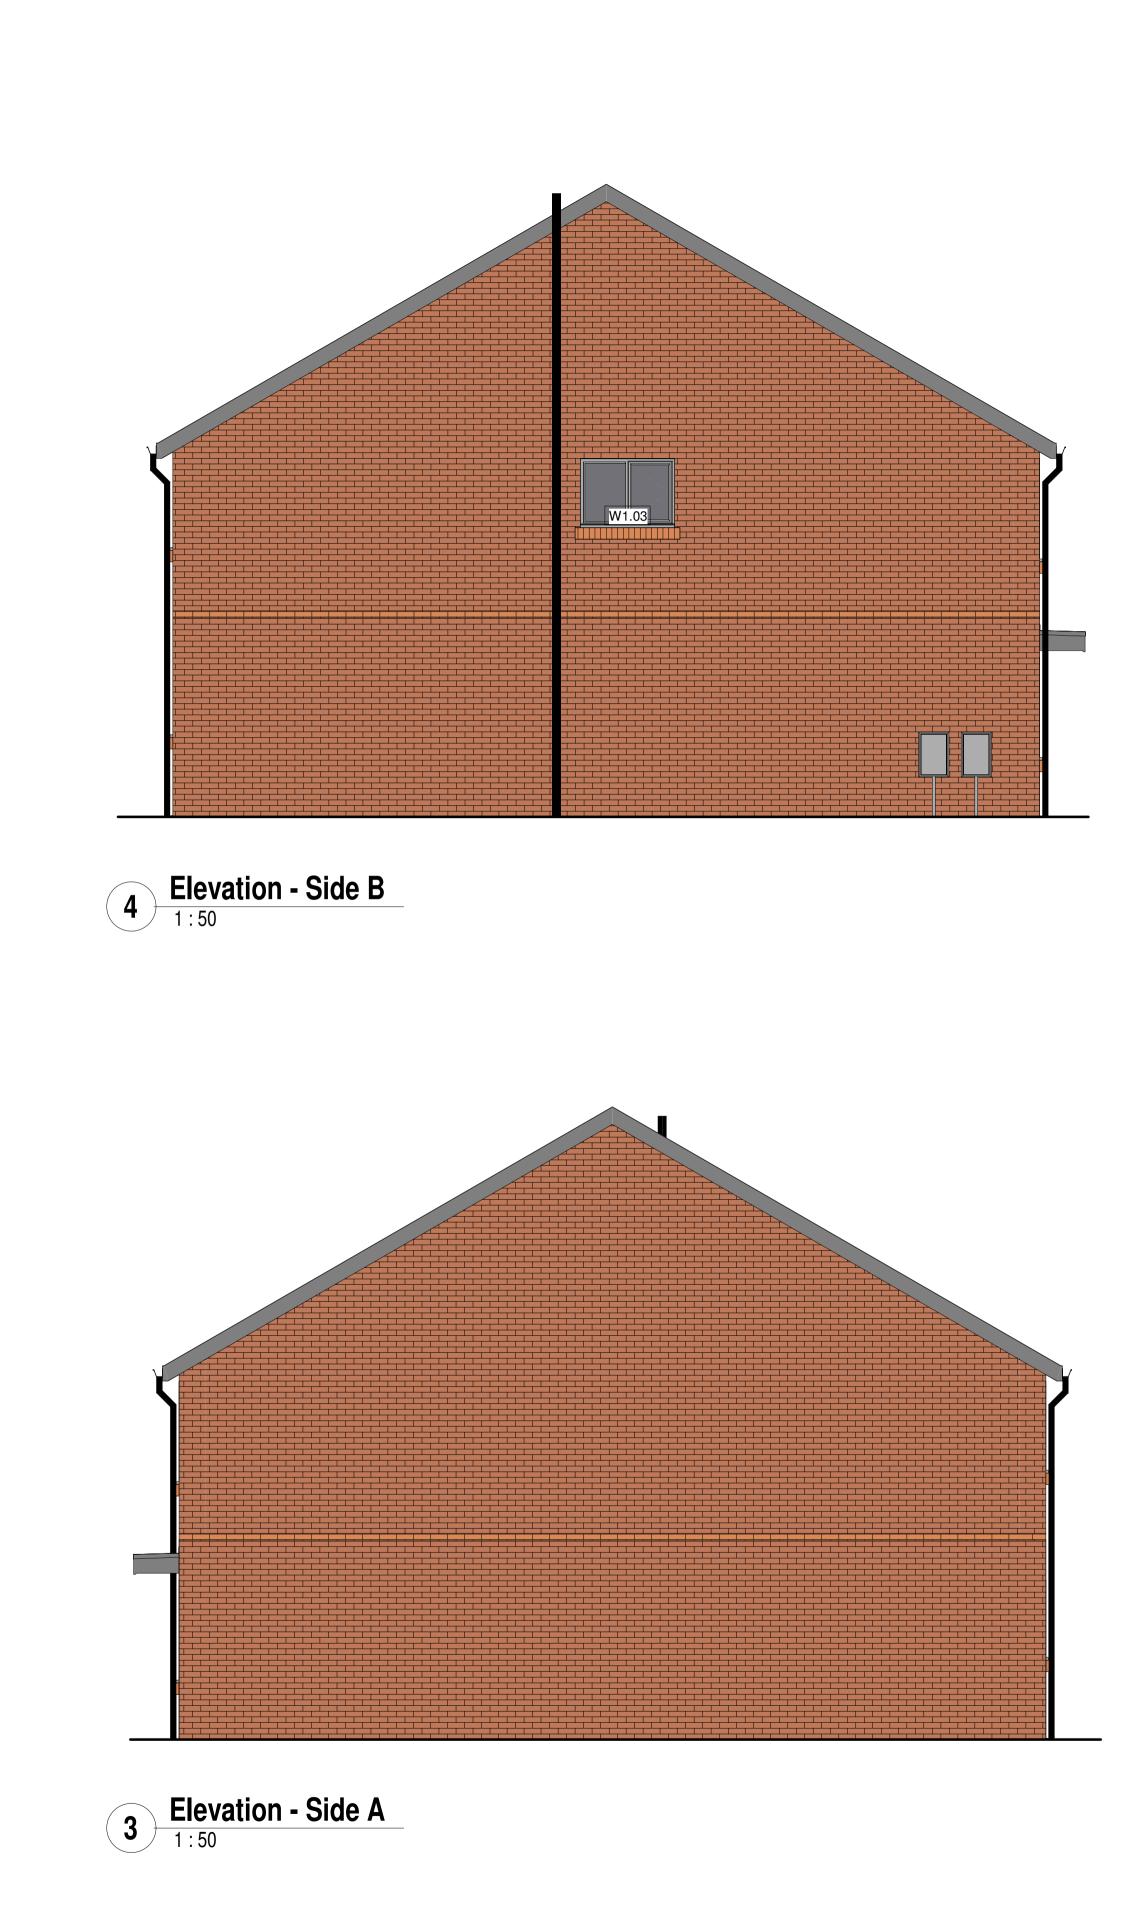

0m 1m 2m 3m 4m 5m VISUAL SCALE 1:50 @ A1

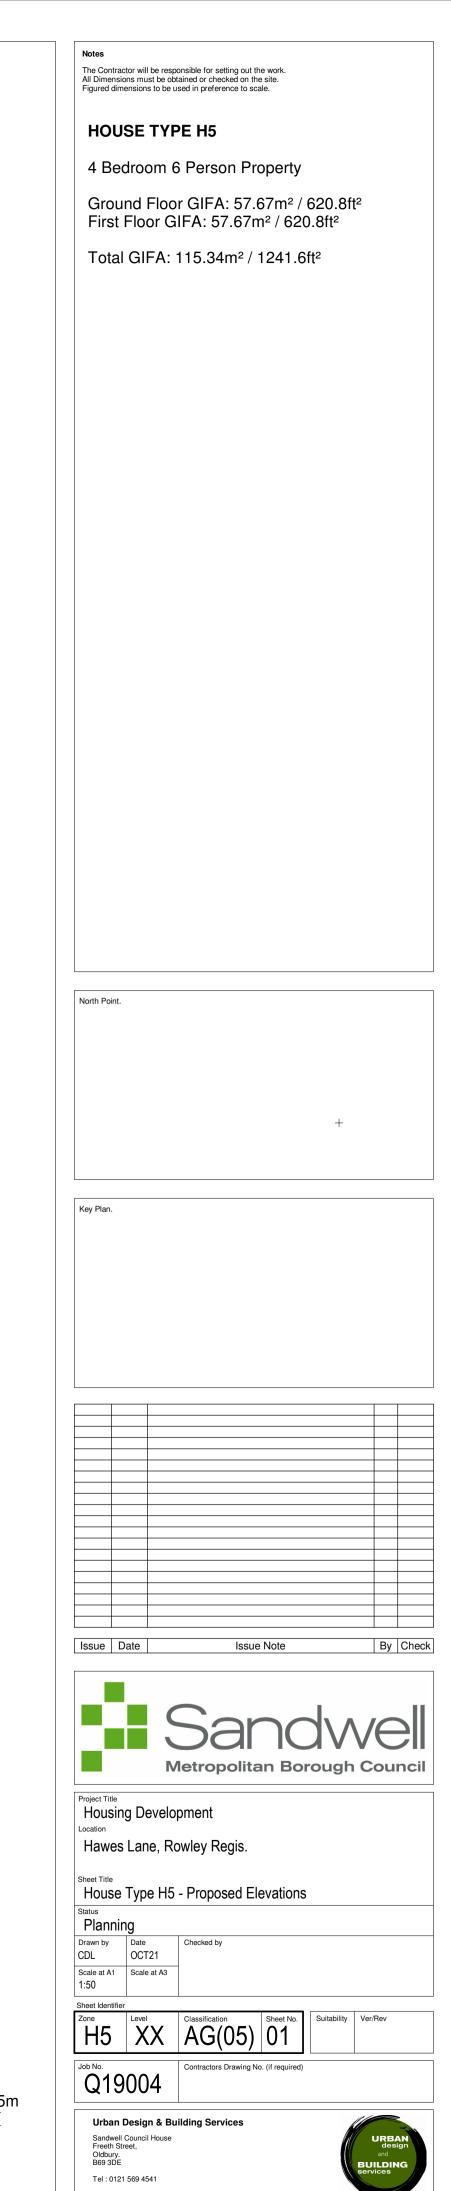

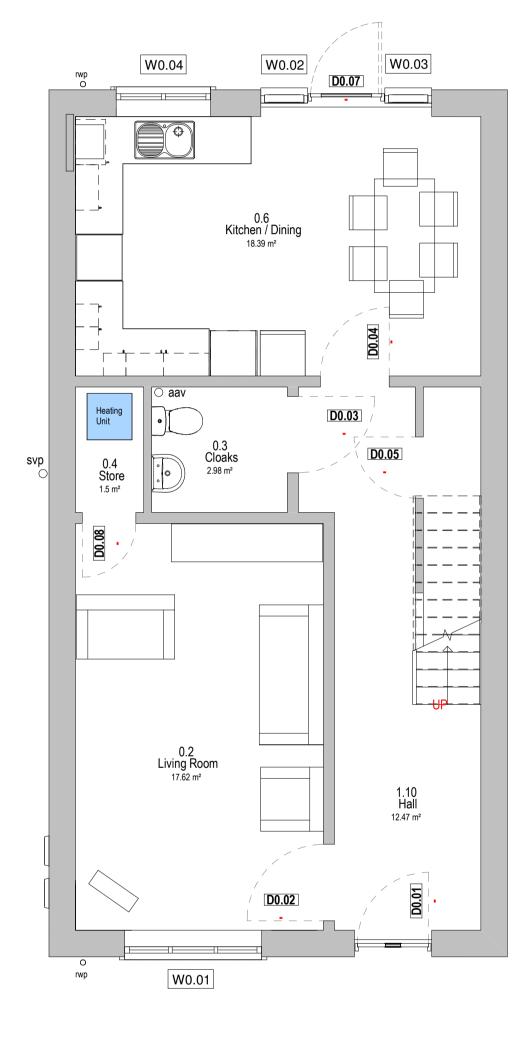








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W1.03




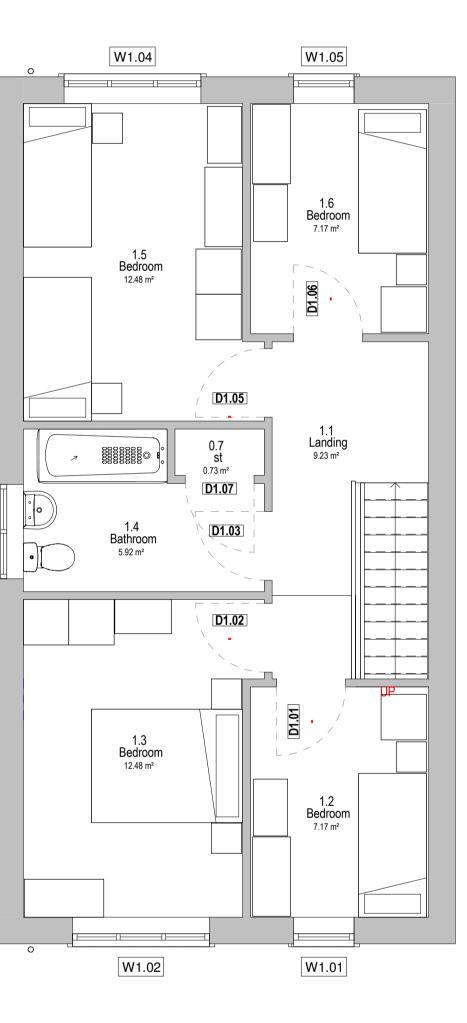

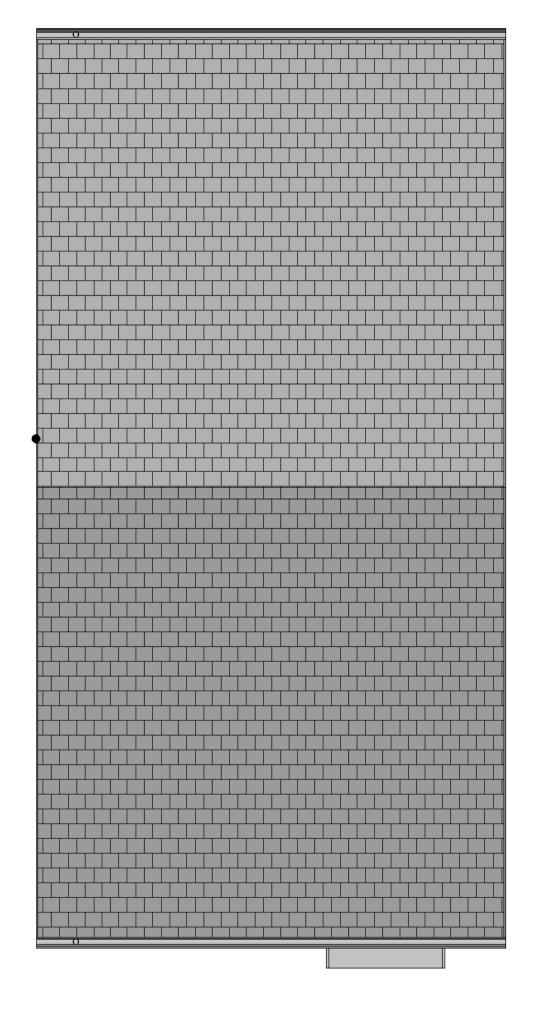

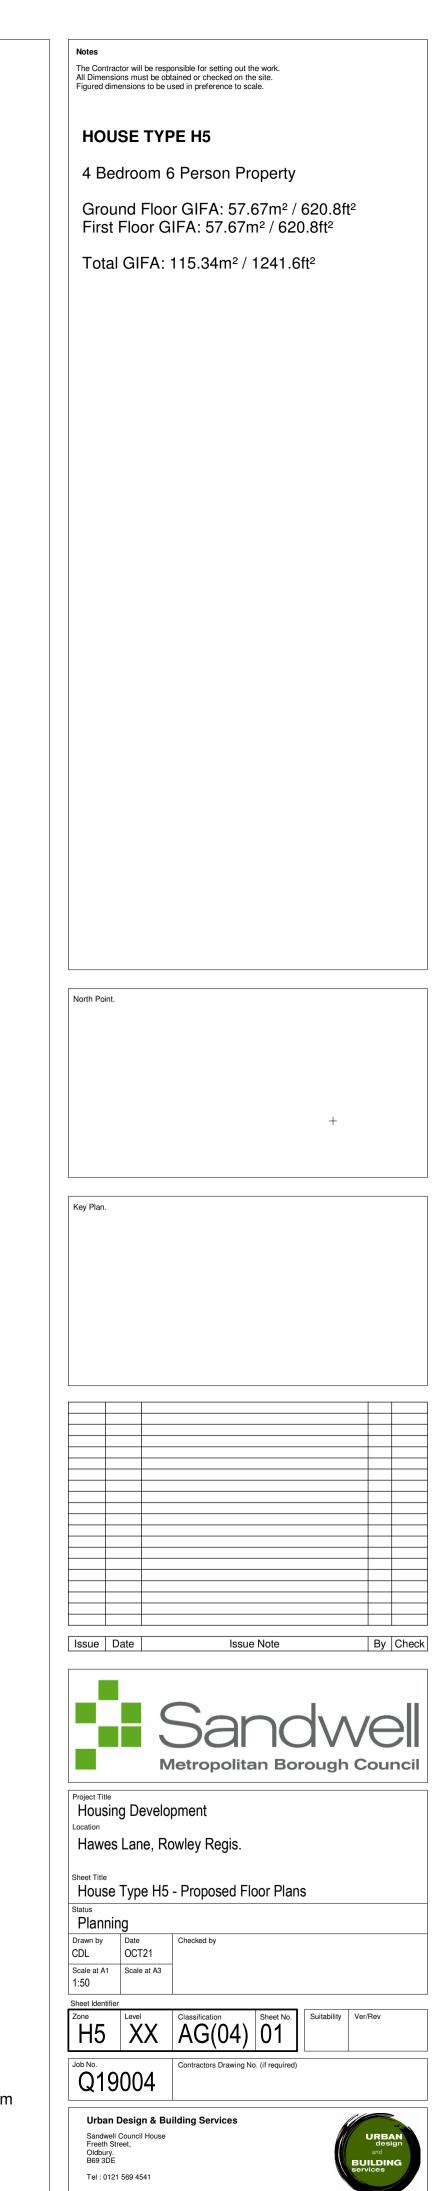


2m 5m 3m 4m VISUAL SCALE 1:50 @ A1

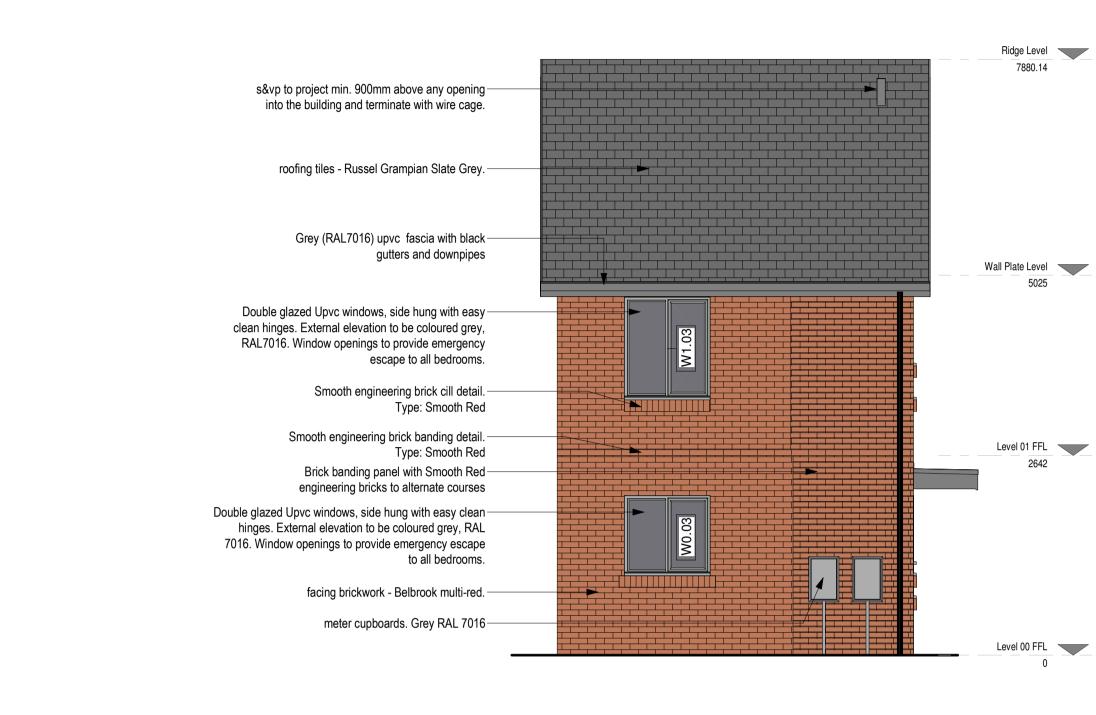









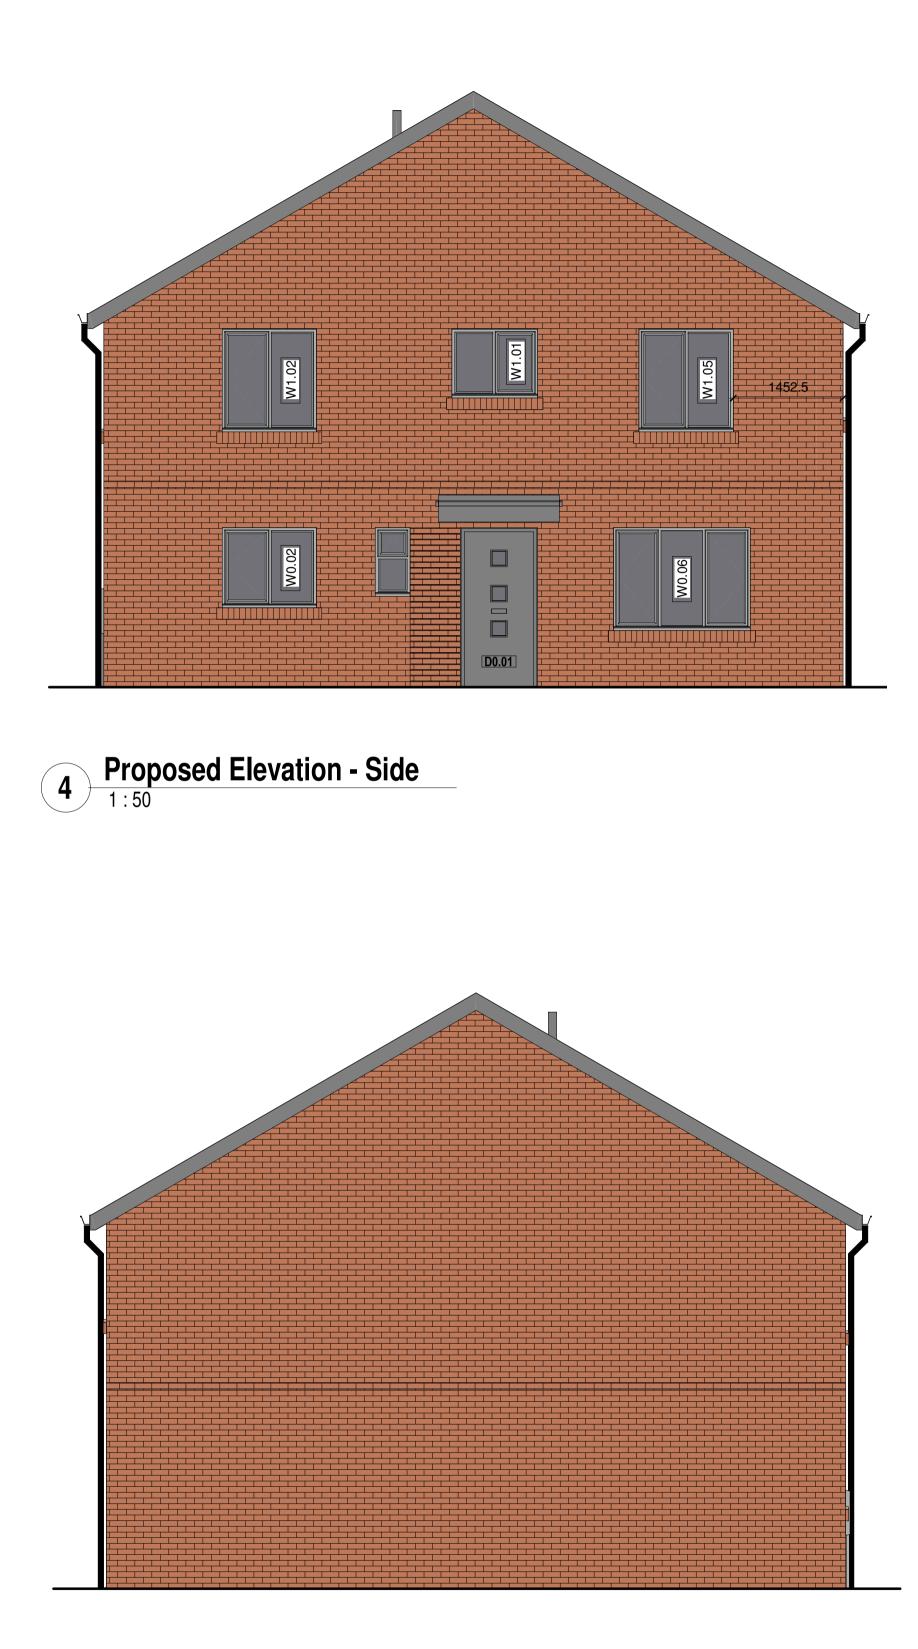

Broposed Elevation - Side 1

0m 1m

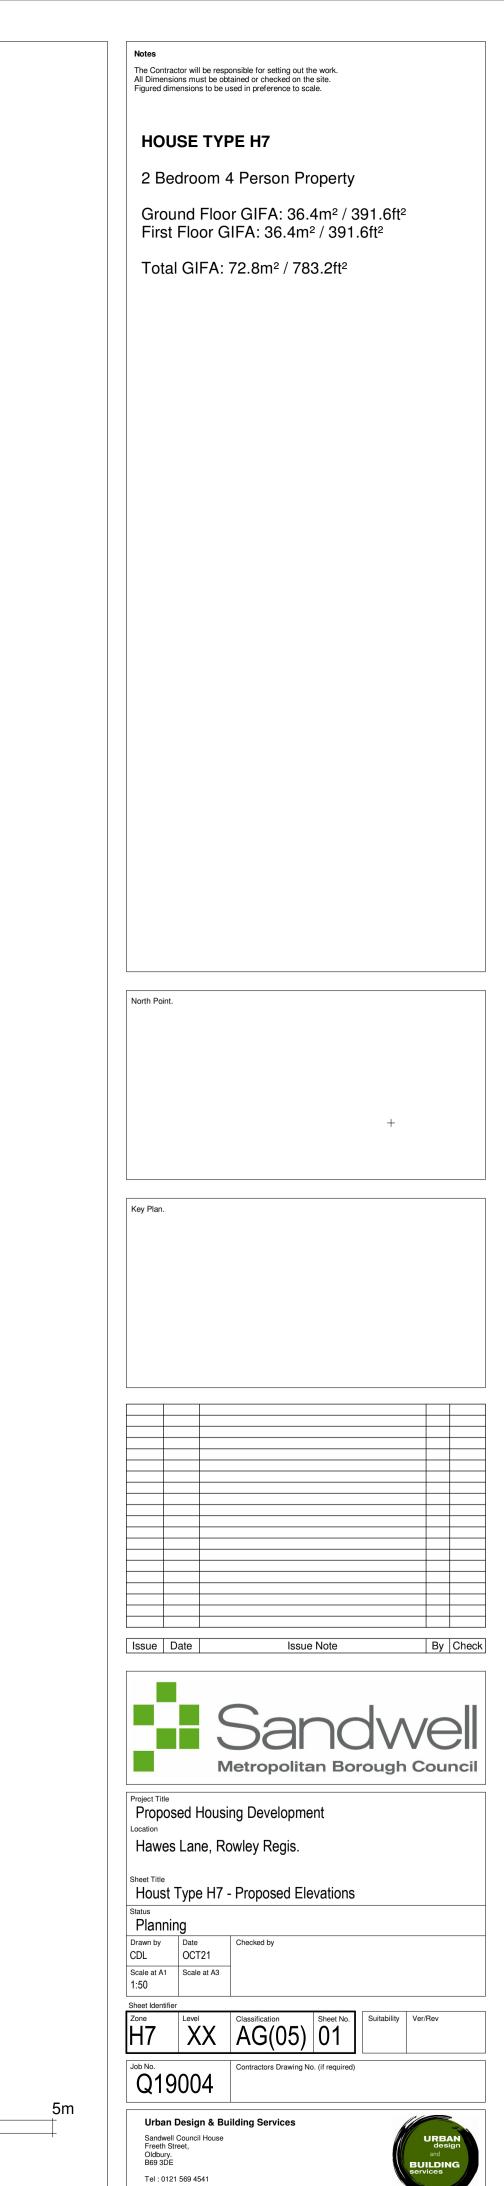


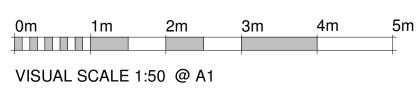

HOUSE TYPE H7

2 Bedroom 4 Person Property

Ground Floor GIFA: 36.4m² / 391.6ft² First Floor GIFA: 36.4m² / 391.6ft²

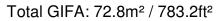



1

VISUAL SCALE 1:50 @ A3

Notes.

The Contractor will be responsible for setting out the work. All Dimensions must be obtained or checked on the site. Figured dimensions to be used in preference to scale.

Key Plan.

Issue	Date	Issue Note	By	Chk



Project Title

Proposed Housing Development

Location


Hawes Lane, Rowley Regis.

Sheet Title

House Type H7 - Alternative Elevation

Status Planning


	•					
Drawn by	Date	Checked by				
CDL	OCT21 Scale at A3					
Scale at A1						
	1:50					
Sheet Identifie	ər					
Zone	Level	Classification	Sheet No.	Suitability	Ver/Rev	

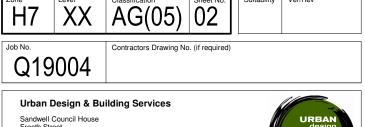


Sandwell Council House Freeth Street, Oldbury. B69 3DE

5m

Tel : 0121 569 4541

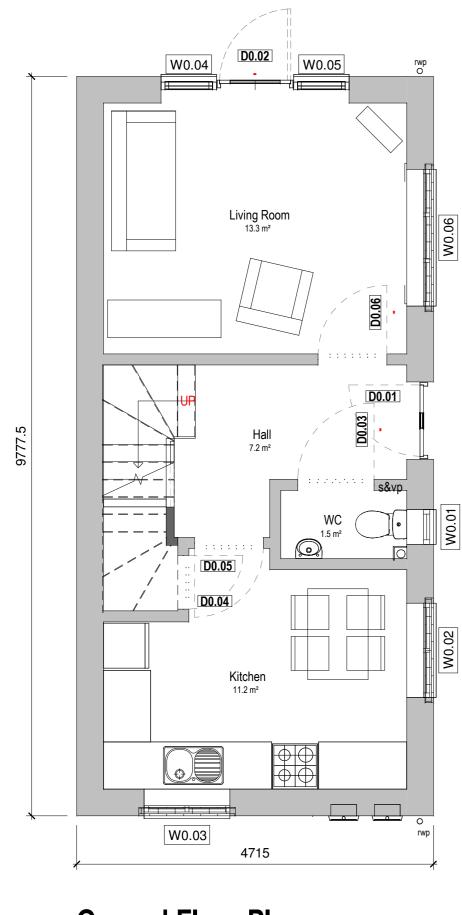



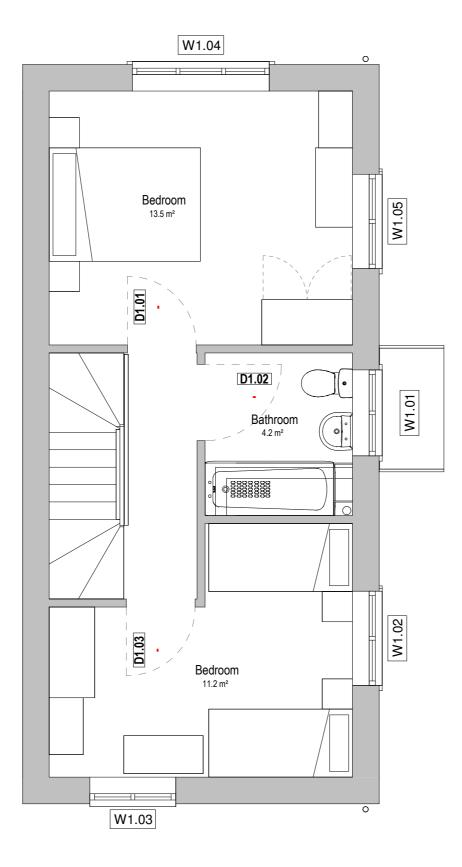



	Ground Floor GIFA
	First Floor GIFA: 36 Total GIFA: 72.8m ²
	Key Plan.
	Issue Date
	Sa
	Metrop
	Project Title Proposed Housing Deve Location
	Hawes Lane, Rowley Re
Roof Plan	Sheet Title House Type H7 - Propos Status
3 1:50	Drawn by Date Checked by CDL OCT21 Checked by
	Scale at A1 Scale at A2 1:50 Sheet Identifier
	Zone Level Classificatio H7 XX AG(
	Job No. Contractors
0m 1m 2m 3m 4m 5m	Urban Design & Building Servi
VISUAL SCALE 1:50 @ A2	Sandwell Council House Freeth Street, Oldbury. B69 3DE Tel : 0121 569 4541

Notes

The Contractor will be responsible for setting out the work. All Dimensions must be obtained or checked on the site. Figured dimensions to be used in preference to scale.

HOUSE TYPE H7

2 Bedroom 4 Person Property

A: 36.4m² / 391.6ft² 36.4m² / 391.6ft²

² / 783.2ft²

Issue Note By Check



velopment

Regis.

Sheet Title House Type H7 - Proposed Floor Plans											
Status											
Planni	ng										
Drawn by	Date	Checked by									
CDL	OCT21										
Scale at A1	Scale at A2										
	1:50										
Sheet Identifie	er										
Zone	Level	Classification	Sheet No.	Suitability	Ver/Rev						
H7	XX	AG(04)	01								
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Job No.		Contractors Drawing No. (if required)									


vices URBAN design













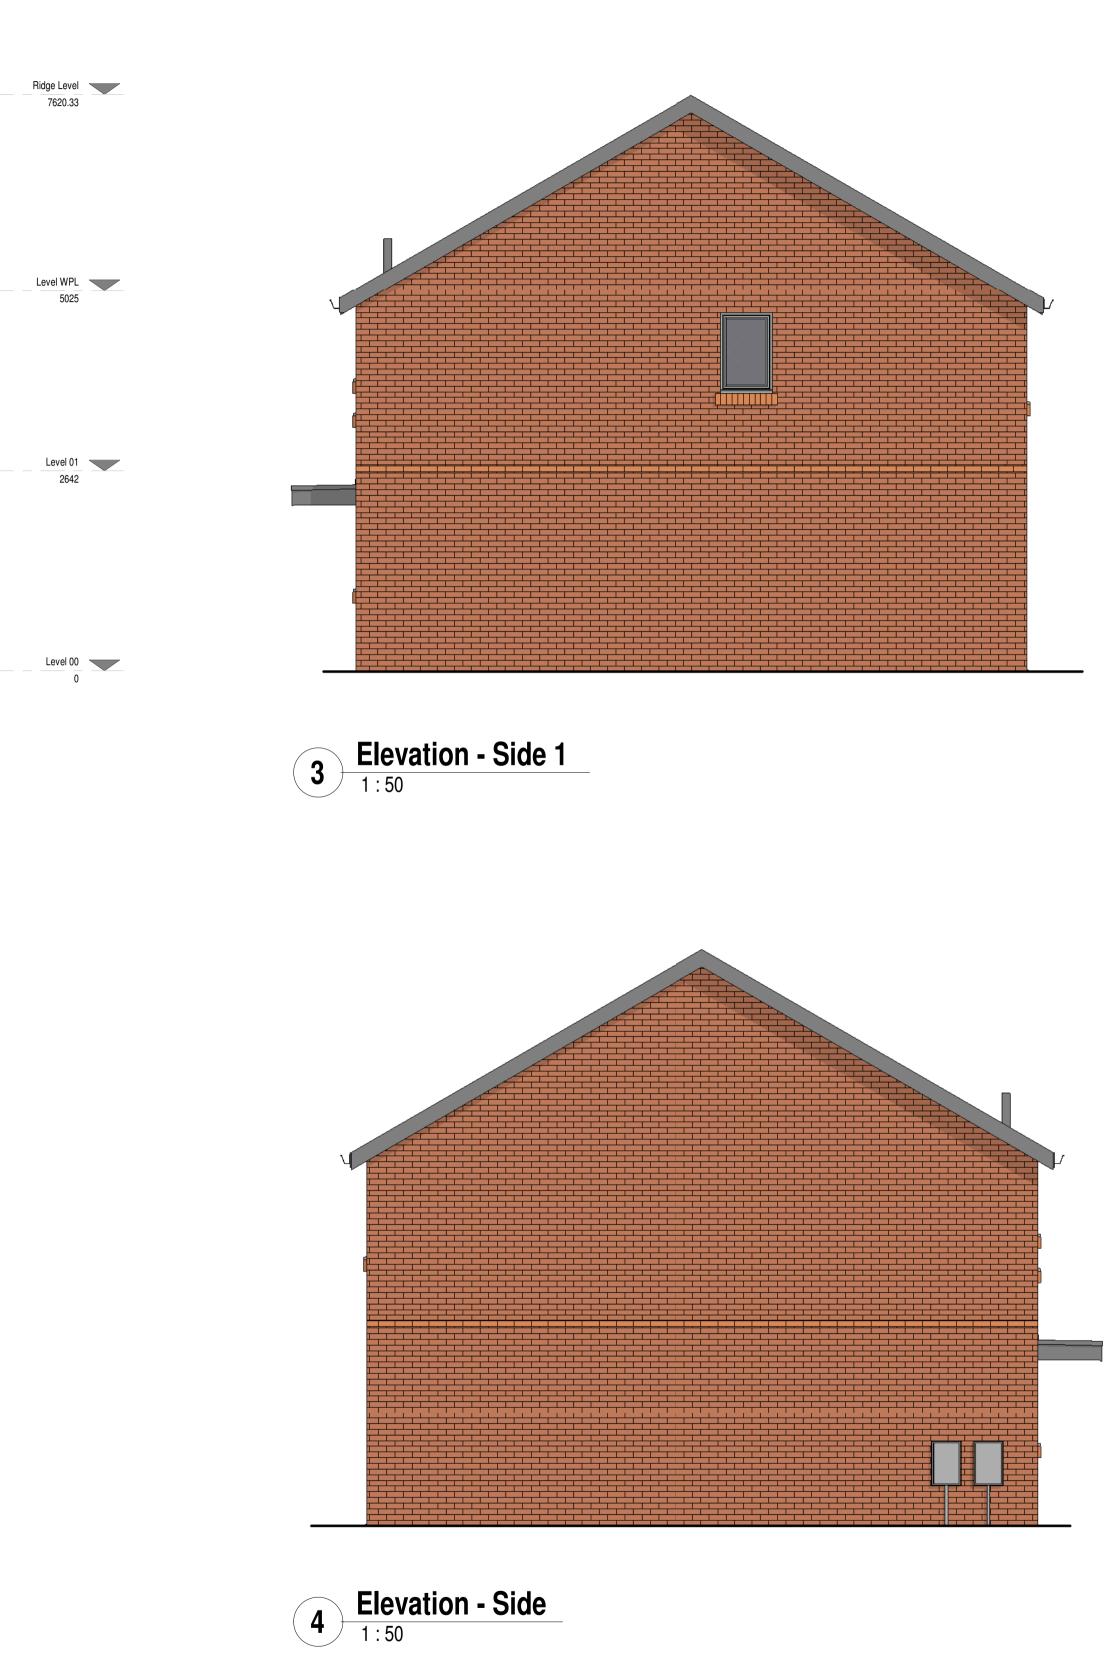

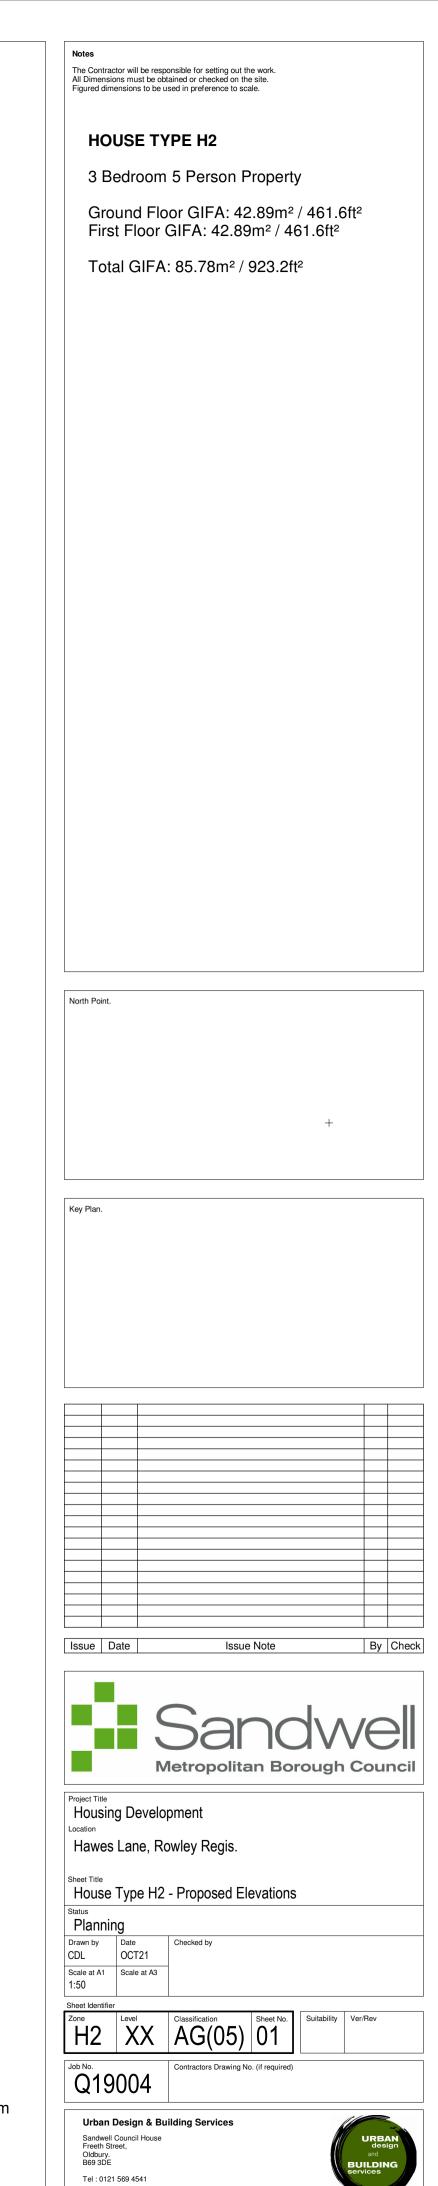

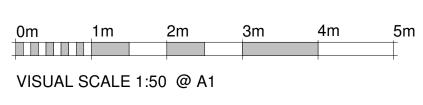

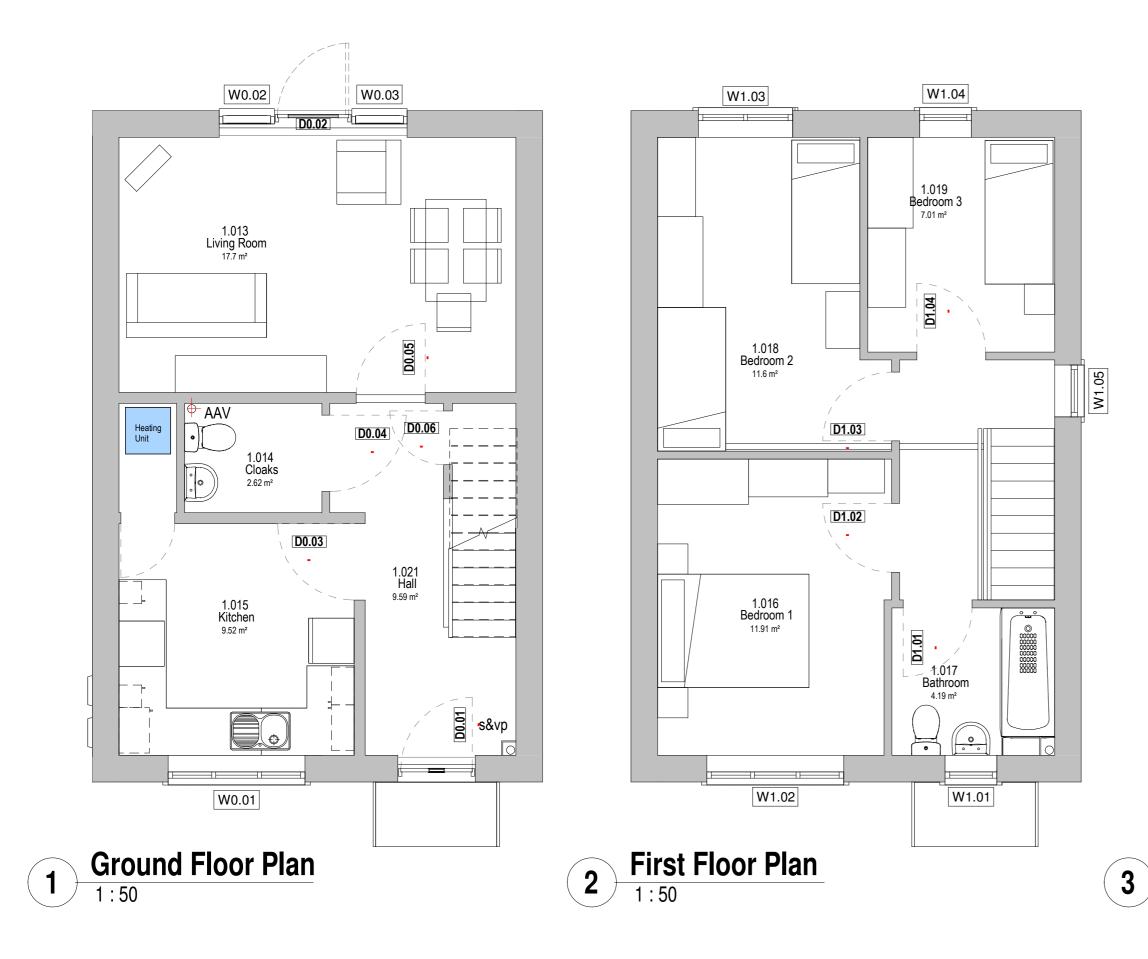

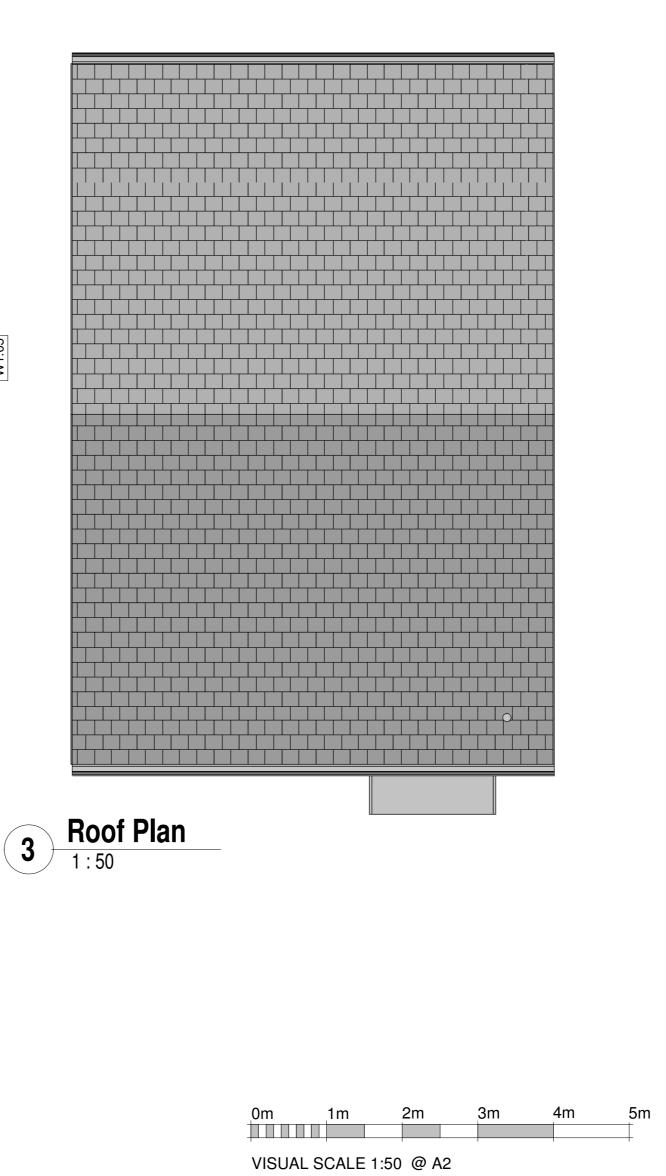

Notes

The Contractor will be responsible for setting out the work. All Dimensions must be obtained or checked on the site. Figured dimensions to be used in preference to scale.

HOUSE TYPE H2

3 Bedroom 5 Person Property

Ground Floor GIFA: 42.89m² / 461.6ft² First Floor GIFA: 42.89m² / 461.6ft²


Total GIFA: 85.78m² / 923.2ft²

Key Plan.													
											1	1]]
Issue D	Date			lss	ue l	Note					Ву	Check]
Project Title Housi		evelo	pment]
Hawe	s Lar	ne, Ro	wley	Regis									
Sheet Title	-		-				_	_					
		e H2	- Prop	osed	FIC	or Pla	ans	5					
Planning Drawn by Date Checked by								-					
CDL Scale at A1	OCT Scale 1:50	at A2											
Sheet Identifi Zone	ier Level		Classific	ation		Sheet N	o.	Suita	bility	Ver	/Rev]
H2	X	X	AG	i(04	.)	01							
Job No.	900)4	Contract	ors Drawin	ng No	. (if requir	ed)						

Urban Design & Building Services


Sandwell Council House Freeth Street, Oldbury. B69 3DE

Tel : 0121 569 4541

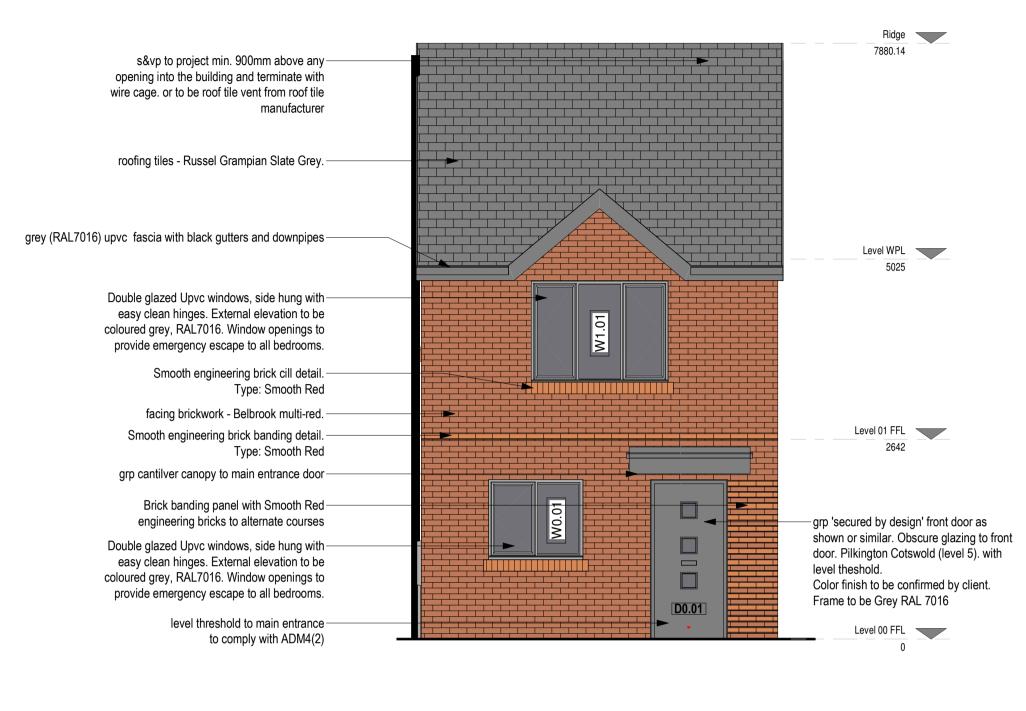







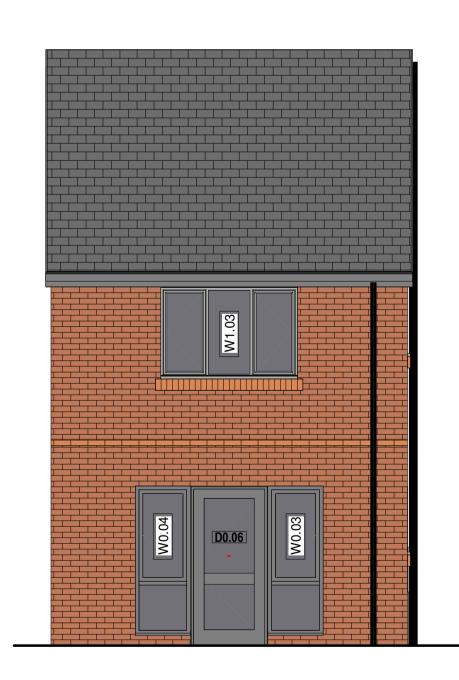




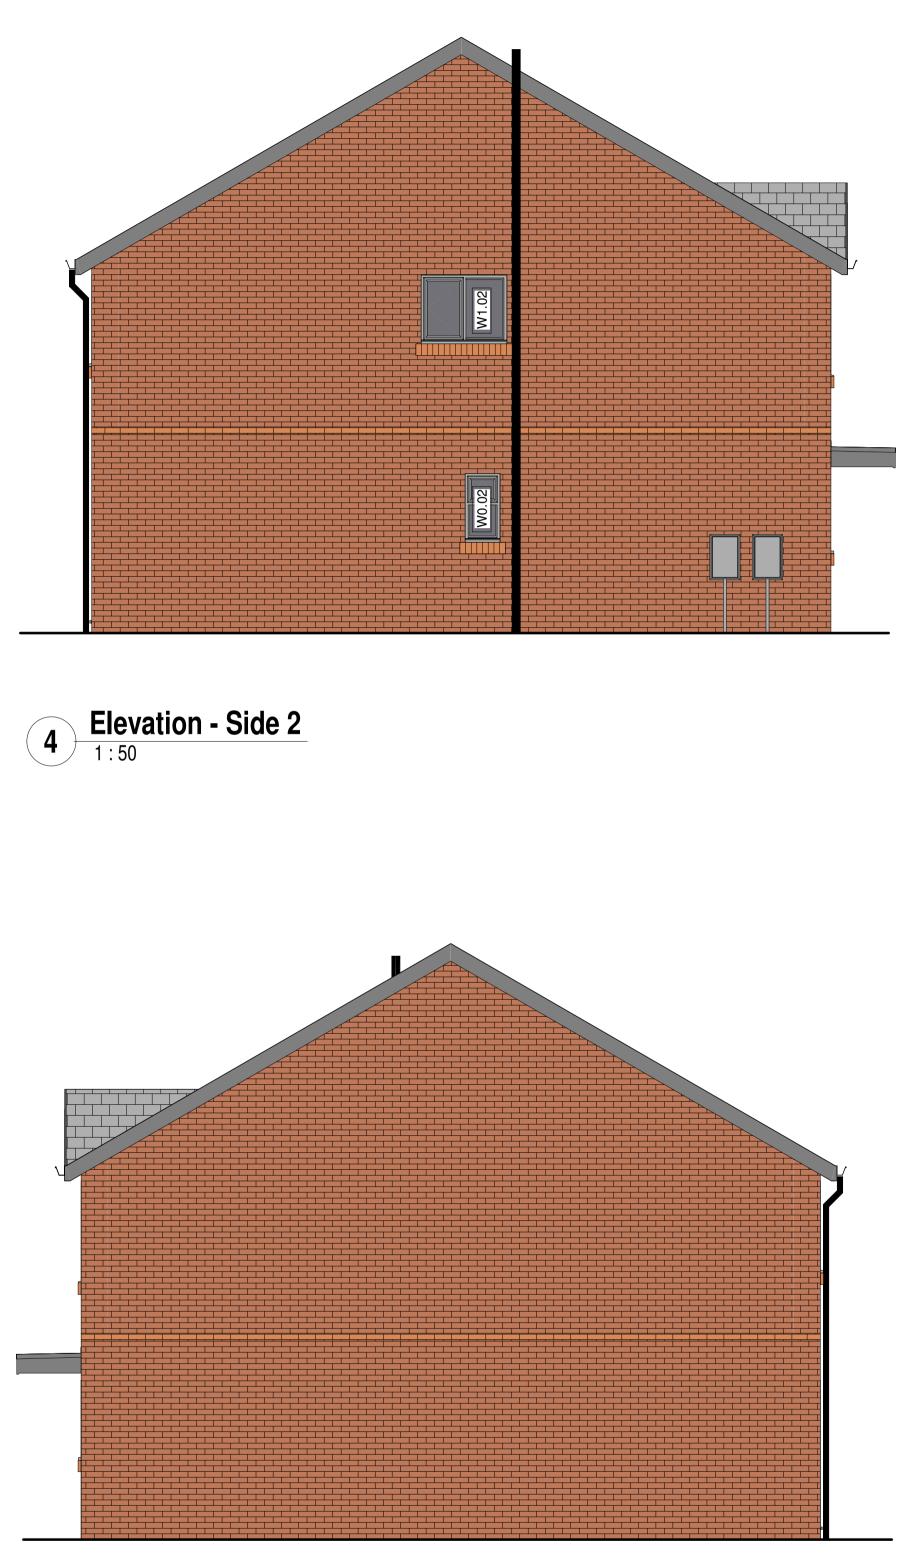


Elevation - Side 1 1:50

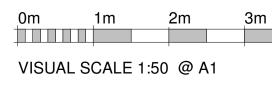

All Dimension	or will be responsible for setting out the work. Is must be obtained or checked on the site.
Figured dimer	nsions to be used in preference to scale.
	e TYPE H1 room 4 Person Property
Ground	d Floor GIFA: 36.4m ² / 391.6ft ²
	loor GIFA: 36.4m ² / 391.6ft ²
	GIFA: 72.8m ² / 783.2ft ²
North Point.	
	+
Key Plan.	
Issue Da	ite Issue Note By Check
	Sandwell
	Metropolitan Borough Council
Project Title Housing) Development
Location	Lane, Rowley Regis.
Sheet Title House 7	Type H1 - Proposed Elevations
Status	9
CDL Scale at A1	Date Checked by OCT21 Scale at A3
1:50 Sheet Identifier Zone	Level Classification Sheet No. Suitability Ver/Rev
H1	XX AG(05) 01
Job No. Q190	Contractors Drawing No. (if required)
Sandwell C	esign & Building Services ouncil House et, URBAN design
Freeth Stree Oldbury. B69 3DE Tel : 0121 5	and BUILDING services

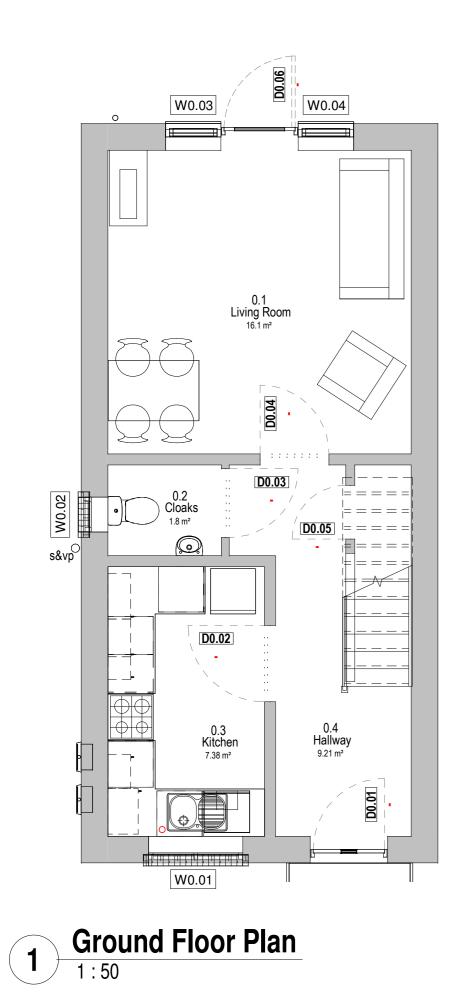

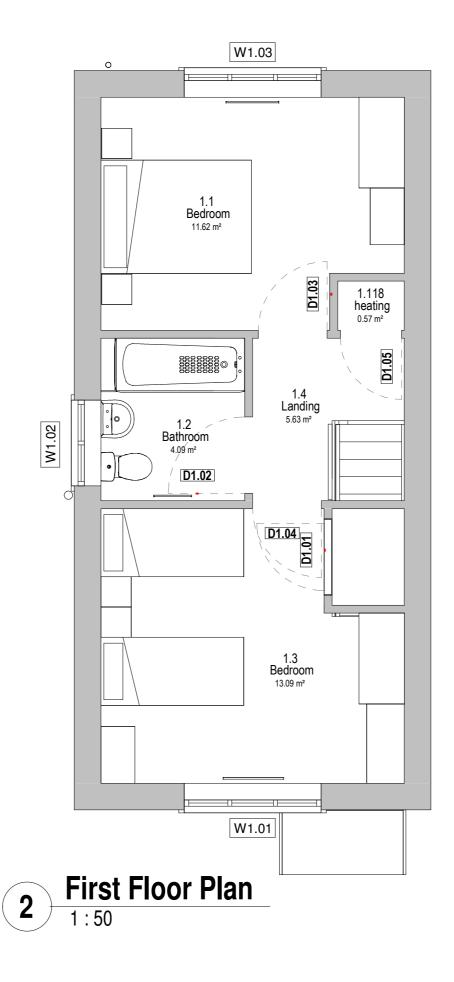

	Notes The Contractor will be responsible for setting out the work. All Dimensions must be obtained or checked on the site. Figured dimensions to be used in preference to scale.
	HOUSE TYPE H1
	2 Bedroom 4 Person Property
	Ground Floor GIFA: 36.4m ² / 391.6ft ² First Floor GIFA: 36.4m ² / 391.6ft ²
	Total GIFA: 72.8m ² / 783.2ft ²
	Key Plan.
	Issue Date Issue Note By Check
	Sandwell
	Metropolitan Borough Council
	Project Title Standard Housing - MAPLE House Type
	Hawes Lane, Rowley Regis.
3 Roof Plan	Sheet Title House Type H1 - Proposed Floor Plans
3 1:50	Status Planning Drawn by Date Checked by
	CDL OCT21 Scale at A1 Scale at A2
	Sheet Identifier Zone Level Classification Sheet No. Suitability Ver/Rev
	H1 XX AG(04) 01
	Job No. Contractors Drawing No. (if required)
0m 1m 2m 3m 4m 5m	Urban Design & Building Services Sandwell Council House Freeth Street,
VISUAL SCALE 1:50 @ A2	Freeth Street, Oldbury, B69 3DE Tel : 0121 569 4541



Russel Grampian Slate Grey. -concrete single lap roof tiles and system

grey (RAL7016) upvc fascia with --black gutters and downpipes

Double glazed Upvc windows, side hung with — easy clean hinges. External elevation to be coloured grey, RAL7016. Window openings to provide emergency escape to all bedrooms.


Smooth engineering brick – cill detail. Type: Smooth Red


facing brickwork - Belbrook multi-red.

GRP entrance canopy -

Brick banding panel with Smooth Red – engineering bricks to alternate courses

grp 'secured by design' front door as shown or — similar. Obscure glazing to front door. Pilkington Cotswold (level 5). with level theshold. Color finish to be confirmed by client. Frame to be Grey RAL 7016

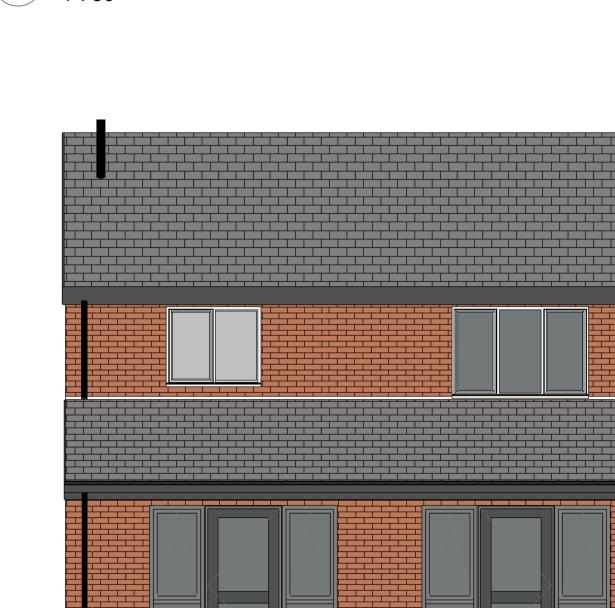


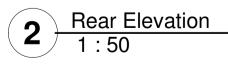





Water Present block HOUSE TYPE H10 3 Bedroom 5 Person Property Ground Floor GIFA: 61.89m² / 666.21% Total GIFA: 123.78m² / 1332.41%	Notes The Contractor will be res	ponsible for setting out the work.	
3 Bedroom 5 Person Property Ground Floor GIFA: 61.89m² / 666.2ft² Total GIFA: 123.78m² / 1332.4ft²	All Dimensions must be o	ptained or checked on the site.	
Round Floor GIFA: 61.89m² / 666.2ft² First Floor GIFA: 123.78m² / 1332.4ft²			
Total GIFA: 123.78m² / 1332.4tt² Neth Post.			66.2ft ²
North Point. Lange			
Key Plan.	TOTAL GIFA:	123.781147 1332.41	£
Key Plan.			
Key Plan. Image: Several se	North Point.		
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Issue Date Issue Note By Check			
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	Issue Date	Issue Note	By Check
		Sanc	well
Sandwell		letropolitan Bord	ough Council
Metropolitan Borough Council	Location		
Project Title Housing Development	Hawes Lane, R	owley Regis.	
Project Title Housing Development Location Hawes Lane, Rowley Regis.	House Type H1 Status	0 - Proposed Elevations	
Project Title Housing Development Location Hawes Lane, Rowley Regis. Sheet Title House Type H10 - Proposed Elevations Status	PlanningDrawn byDateCDLOCT21	Checked by	
Metropolitan Borough Council Project Title Housing Development Location Hawes Lane, Rowley Regis. Sheet Title House Type H10 - Proposed Elevations Status Planning Drawn by Date Checked by	Scale at A1 Scale at A3 1:50 Sheet Identifier		
Metropolitan Borough Council Project Title Housing Development Location Hawes Lane, Rowley Regis. Sheet Title House Type H10 - Proposed Elevations Status Planning Drawn by CDL Date OCT21 Checked by Scale at A1 1:50 Scale at A3 Checked by	Zone Level	Classification Sheet No. AG(05) 01	Suitability Ver/Rev
Metropolitan Borough Council Project Title Housing Development Location Hawes Lane, Rowley Regis. Sheet Title House Type H10 - Proposed Elevations Status Planning Drawn by Date OCT21 Checked by Scale at A1 Scale at A3 1:50 Sheet Identifier Zone Level Classification Sheet No.	Job No.	Contractors Drawing No. (if required)	
Metropolitan Borough Council Project Title Housing Development Location Hawes Lane, Rowley Regis. Sheet Title House Type H10 - Proposed Elevations Status Planning Drawn by CDL Date OCT21 Scale at A1 1:50 Scale at A3 Sheet Identifier Classification AG(05) Sheet No. 01 Suitability Ver/Rev Job No. Contractors Drawing No. (if required)	Urban Design & B	uilding Services	
Metropolitan Borough Council Project Title Houssing Development Location Hawes Lane, Rowley Regis. Sheet Title House Type H10 - Proposed Elevations Status Planning Date OCT21 Scale at A1 Scale at A3 1:50 Checked by Sheet Identifier Checked by Sheet Identifier Sheet No. 20ne Level Classification M10 XX AG(05) Dth Job No. Q19004 Contractors Drawing No. (if required) Vban Design & Building Services Mathematica	Freeth Street, Oldbury. B69 3DE		URBAN design and BUILDING services
Metropolitan Borough Council Project Title Housing Development Location Hawes Lane, Rowley Regis. Sheet Title House Type H10 - Proposed Elevations Status Planning Drawn by Date OCT21 Checked by Scale at A1 Scale at A3 1:50 Checked by OCT21 Checked by Status Planning Drawn by Date OCT21 Checked by Scale at A1 Scale at A3 1:50 Chassification M100 XX AGG(05) 01 Job No. Contractors Drawing No. (if required) Vban Design & Building Services Sardwell Council House Sardwell Council House Sardwell Council House Presh Street, Oldburg, Be 3DE Sardwell Council House	Tel : 0121 569 4541		


	1m		2m		3m	4m	5m
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S	CALE	1:50	@ A	1			

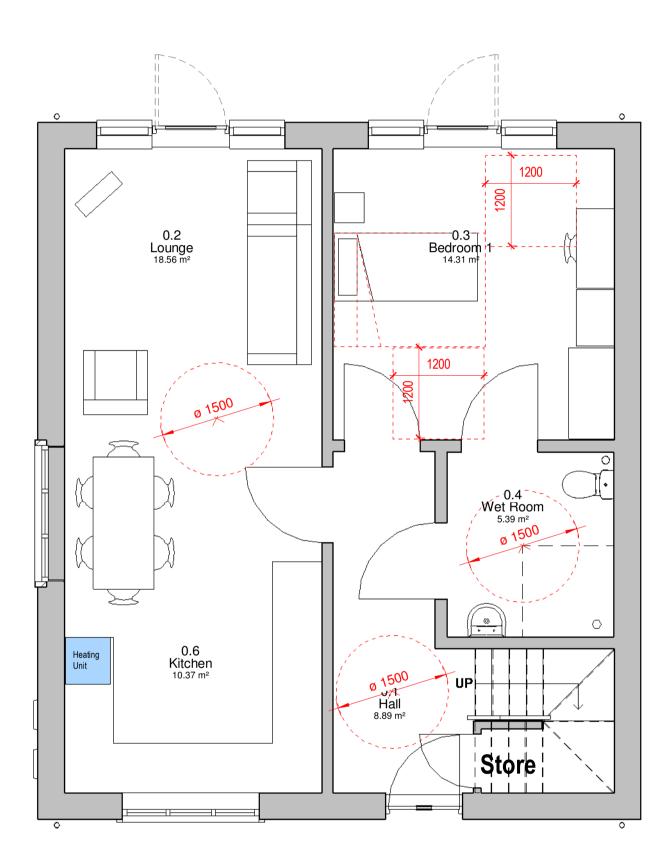


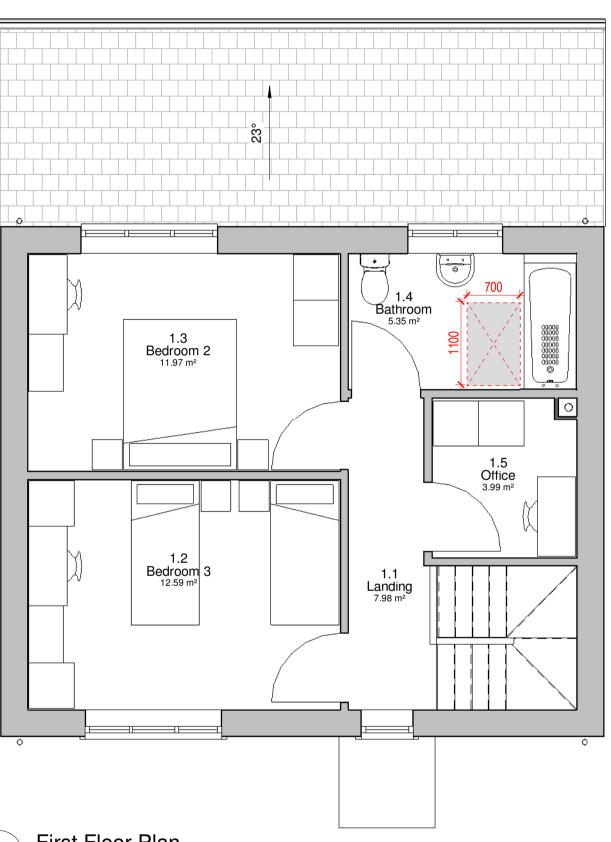


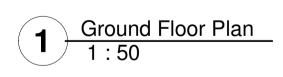

2 First Floor Plan 1 : 50

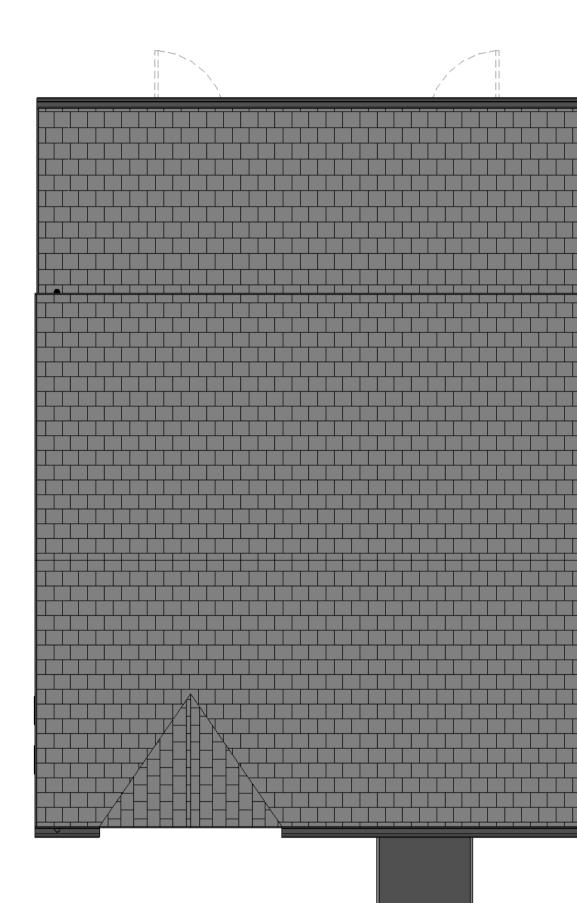

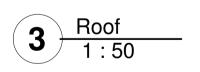

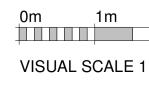

	Nute The Contractor will be responsible for setting out the work. All pimensions must be obtained or checked on the site. Figured dimensions to be used in preference to scale. HOUSE TYPE H10 3 Bedroom 5 Person PropertyGround Floor GIFA: 61.89m² / 666.2ft²First Floor GIFA: 61.89m² / 666.2ft²Total GIFA: 123.78m² / 1332.4ft²
	North Point. +
	Image: Sector
2m 3m 4m 5m .50 @ A1	<image/> Project Title Housing Development Location Haves Lane, Rowley Regis. Status Planning Disce Type H10 - Proposed Floor Plans Status Planning OCT21 Scale at A1 Scale at A2 Scale at A1 Scale at A2 Scale at A3 Scale at A1 Scale at A2 Scale at A3 Scale at A2 Scale at A3 Scale at A4 Mathing Math



Proposed drop/ dropper kerb. Refer to Civil engineers details/ drgs

Proposed edging kerb, refer to Civil Engineers details/ drgs

Proposed pre cast concrete slab paving. Tobermore Mayfair paving 400x400x40mm. Refer to Civil Engineers drawings

Proposed pre cast concrete slab paving for overrun areas, Tobermore Mayfair paving 400x400x65mm. Refer to Civil Engineers drawings

Proposed block paved parking bays: Marshalls Tegula pavers, 240 x160mm, colour Harvest laid herringbone pattern to Civil Engineers drgs/ spec

Proposed bound gravel paving

Proposed loose gravel paving

Proposed steel barrier fencing height 1100mm

Proposed steel vertical bar barrier fence height 1800mm

Proposed steel railing height 1000mm

Proposed 1800mm high steel vertical bar fence

Proposed 1800mm high timber close board fence.

Proposed 1800mm high timber close board gate.

Proposed 1800mm high timber palisade fence

Proposed 1800mm high timber hit and miss palisade fence

Existing retaining wall

Proposed retaining wall

Proposed retaining wall topped by 1100mm high steel barrier fence/ handrail Proposed handrail

Proposed turf areas

Proposed shrub planting

Existing tree to be retained

Existing tree to be removed

Proposed tree planting

Enclosure for storage of 240l capacity domestic bins.

St GILES CHURCHYARD Provisional subject to landowners and planning approval; Fell 3 mature Sycamore within cemetery. -Steel vertical bar barrier fence

height 1100mm mounted on top of retaining wall -Existing Pier.

~1800mm high Steel vertical bar barrier fence.

Line 3.44m from front face of cemetery wall and fence (No additional allowance for piers.)

The Contractor will be responsible for setting out the work. All dimensions must be obtained or checked on the site. Figured dimensions to be used in preference to scale.

All trees within the vicinity of the works and which are to be retained are to be protected by temporary protective fencing to BS 5837 2005. All excavation, grading, filling, paving, cultivation, seeding and turf laying works within the root protection areas of the trees as shown on the tree survey drawing are to be carried out by hand. If tree roots are encountered do not sever and obtain further instructions before proceeding.

Existing cover levels of inspection chambers, gullys and rodding eyes etc to be adjusted as required. Allow also for the lowering of existing services where required.

Key Plan.

North Point.



P0.9 25-10-21 Indicated 3 trees for potential removal- churchyard НН --P0.8 14-10-21 Added stepped access off back of pavement to blocks of flats Amended height of barrier railing to retaining walls adjacent to blocks of flats Majority of propsed trees removed. P0.7 04-10-21 Bungalows reorientated. Added terracing rear gdn plots 3 and 4 Revised burgalow and flat layouts of 30-09 Inserted. Bin type/ storage amended. Visibility protection areas indicated. E. flats: Kerb line amended by parking bay 1.
 P0.6
 14.09-21
 Amended parking rear of flats to mai

 P0.5b
 19-07-21
 Amended parking front plots 3-4 and

 P0.4
 13-07-21
 Tree survey dwg inserted as X-ref
 Amended parking rear of flats to maintain min dist from cemetery wall/ fence HH Amended parking front plots 3-4 and western flats variation b HH P0.3 26-04-21 Adjusted flat positions to be 2m away from Tree root protection area HH Shortened rear gardens plots 5 to 9 and amended path, bin store and parking positions
 P0.2
 21-04-21
 Tree surve inserted as PDF underlay

 P0.1
 25-03-21
 Flats moved additional 1m from Ash tree and revised parking
 нн By Check Rev Date Revision Note

Proposed Housing Development Location

Checked

Hawes Lane Cradley Heath Sheet title

Proposed fence layout Status Planning

Drawn by Date HH 18-01-21

Scale at A1 Scale at A3 1:200 Sheet Identifier

Suitability Ver/Rev Level Classification Sheet No. Classification Sheet No. Classification 01 Sheet No. 00 Job No. Contractors Drawing No. (if required) Q19004 Urban Design & Building Services

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